

3D View 1 - PROPOSED GRANNY FLAT

ROCKHAMPTON REGIONAL COUNCIL

APPROVED PLANS

These plans are approved subject to the current conditions of approval associated with

Development Permit No.: D/22-2025

Dated: 7 April 2025



Artist Impressions are indicative only and construction detail is not to be assumed - final finishes & details may vary

Ph 07 5635 8990 team@dchouse.com.au DE HOUSE 23-25 Prosper Crescent Burleigh Heads 4220 aBCC LIC 1310310 ACN 640 265 974 ABN 19 604 265 974

© 2023 REPRODUCTION IN PART OR WHOLE IS STRICTLY FORBIDDEN

GENERAL NOTES:

- REFRIGIRATORS, DISHWASHERS, FREEZERS AND WASHING MACHINE SYMBOLS ARE FOR POSITIONING PURPOSES ONLY

- WINDOWS DIMENSIONED AS HEIGHT X WIDTH DOORS AND CUPBOARDS DIMENSIONED AS WIDTH

- 1. BUILDER TO VERIFY ALL DETAILS AND DIMENSIONS PRIOR TO SITE START 2. WRITTEN DIMENSIONS TAKE PRECEDENCE OVER SCALE
- DO NOT SCALE FROM PLAN
 ALL WORK TO COMPLY WITH THE PROVISIONS OF THE BUILDING CODE OF AUSTRALIA, AUSTRALIAN STANDARDS AND ANY BYLAWS OR REQUIREMENTS OF THE LOCAL AUTHOR

 5. TERMITE PROTECTION: TREATMENT AS PER AS 3660 - 2004 & AS3600. 1/2009 (A)&(B) 6. ALL PROPOSED WORKS TO BE APPROVED BY A LICENCED CERTIFIER PRIOR TO CONSTRUCTION & ALL STRUCTURAL WORK SUBJECT TO ENGINEER DESIGN & SPECS.

JOB DESCRIPTION: PROPOSED DUAL OCCUPANCY CLIENT: DC HOUSE TEAM REVISION: ISSUE / DATE: REVISION D CERTIFICATION SITE ADDRESS: ISSUE REVISION E MONDAY, 24 MARCH 11 James St, Gracemere, QLD 4702 2025 REVISION F

3D View 2 - PROPOSED GRANNY FLAT

DRAWING LIST

Sheet Number

Sheet Name

PERSPECTIVE GENERAL NOTES GENERAL NOTES

GROUND FLOOR PLAN CARPORT PLAN ELEVATIONS SECTION ROOF PLAN ELECTRICAL FLOOR COVERINGS DETAILS

FIRE SEPARATION DETAIL CABINETRY DETAIL 1 CABINETRY DETAIL 2

JOB NO: DRAWING TITLE: DESIGN: J2094 SHEET NO: PERSPECTIVE 01 **DCH 18** CHECKED BY: A3 KA/MT

SITE GENERAL NOTES:

1. WRITTEN DIMENSIONS TAKE PRECEDENCE OVER SCALE.

ADDRESS:

SITE AREA:

PARISH:

COUNTY:

LOT NUMBER:

PLAN NUMBER:

LOCAL AUTHORITY:

BUILDING AREA:

SITE COVERAGE:

- 2. BUILDER TO VERIFY ALL BOUNDARY CLEARANCES AND SITE SET OUT DIMENSIONS PRIOR TO COMMENCEMENT OF CONSTRUCTION
- 3. LEVELS AND CONTOURS ARE BASED ON ASSUMED DATUM.
- 4. VEHICULAR CROSS OVERS TO BE
 CONSTRUCTED AS PER LOCAL COUNCIL
 REQUIREMENTS AND/OR APPROVAL.
 5. THIS SITE PLAN IS A TRANSCRIPTION OF
 THE ORIGINAL CONTOUR/ID SURVEY OR SITE
 PLAN, THE BUILDER AND SUB-CONTRACTORS
 ARE TO VERIFY ALL INFORMATION CONTAINED
 HEREIN PRIOR TO SITE START AND ANY
 DISCREPANCY RESOLVE WITH THIS OFFICE
 PRIOR TO CONSTRUCTION.
- 6. IT IS RECOMMENDED TO OBTAIN A NEW CONTOUR AND/OR IDENTIFICATION SURVEY PLAN PRIOR TO COMMENCEMENT OF WORK.
 7. SEWER TO HOUSE CONNECTION AND WATER MAIN TO HOUSE CONNECTION PLOTTED FROM GCCC INFRASTRUCTURE ASSET MAPPING INDICATIVE ONLY, SUBJECT TO SURVEY OR SERVICE LOCATION

SITE PREPARATION & DRAINAGE NOTES:

1. ROOFWATER TO BE PIPED VIA 100mm & PVC PIPE TO COUNCIL STORMWATER DRAINAGE SYSTEM OR ON SITE RAIN WATER TANKS IF APPLICABLE, WITH OVERFLOW TO DIRECT TO RUBBLE PITS OR COUNCIL DISCHARGE SYSTEM AS PER APPROVAL REQUIREMENTS.

2. ROOF AND SURFACE WATER TO COMPLY WITH COUNCIL PLUMBING AND DRAINAGE SERVICES CONDITIONS OF APPROVAL.

3. ALL HOUSEHOLD SEWER AND WASTE TO BE DISCHARGED TO COUNCIL SEWER SYSTEM OR ON SITE SEWERAGE FACILITY IF APPLICABLE - OSSF TO BE REVIEWED BY A QUALIFIED CONSULTANT

4. SITE CLASSIFICATION AND FOOTING/SLAB PREPARATION REFER NCC VOL 2. PART 3.2. 5. ALL GUTTERS AND DOWNPIPES TO ADHERE TO NCC VOL 2. PART 3.5.2.

6. ON SITE RAIN WATER HARVESTING WHERE NOT DIRECT LINES FROM ROOF/GUTTER TO HAVE CHARGED LINES. REFER MANUFACTURER INSTALLATION & SPECIFICATIONS.

7. ALL RETAINING WALLS GREATER THAN 1,000 IN HEIGHT TO BE DESIGNED BY A REGISTERED PRACTICING STRUCTURAL ENGINEER (RPEQ).

TERMITE PROTECTION:

1. TERMITE PROTECTION IS A VISUAL BARRIER SYSTEM WITH APPROVED COLLARS AT PENETRATIONS IN ACCORDANCE WITH AS3660 2004 & AS3600.1/2009. - REFER TO CONDITIONS OF APPROVAL

2. ALL TERMITE PROTECTION TO BE INSTALLED IN ACCORDANCE WITH MANUFACTURERS SPECIFICATIONS

REAL PROPERTY DESCRIPTION

11 James St, Gracemere, QLD 4702

1104.81m² 01

RP608107

ROCKHAMPTON CITY COUNCIL 156.48m²

14%

SURVEYING NOTE

CONTOUR / DETAIL SURVEY / LEVELS NOT PROVIDED BY OWNER.

IT IS RECOMMENDED TO CARRY OUT A DETAIL SURVEY PRIOR TO FINALISING DESIGN, AND ANY DISCREPANCIES RESOLVE WITH THIS OFFICE.

IT IS THE BUILDER'S RESPONSIBILITY TO CONDUCT AN I DENT SURVEY AND SEWER LOCATION PRIOR TO CONSTRUCTION


DUAL OCCUPANCY NOTES

- car parking spaces to comply with AS2890.1 2 covered and 2 uncovered
- setbacks in accordance with QDC MP1.3
- prior to construction builder to locate sewer line and ensure footing setback is 1200mm minimum from sewer, clearance above sewer connection 2500mm minimum -

to comply with QDC part MP1.4

- any alteration to existing vehicular crossovers to comply with the local authority

requirements

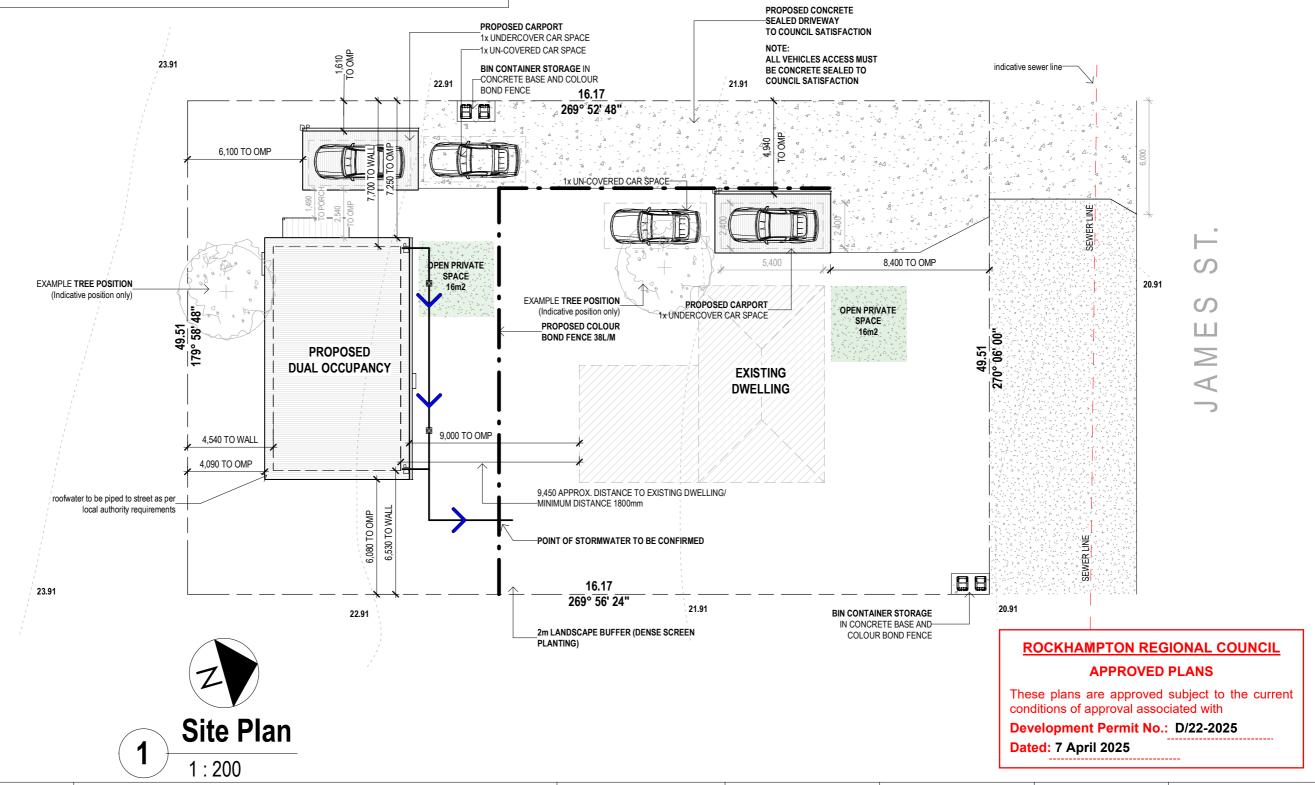



DC HOUSE GENERAL NOTES:

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AUSTRALIAN STANDARDS AND ANY BYLAWS OR REQUIREMENTS OF THE LOCAL AUTHOR
5. TERMITE PROTECTION: TREATMENT AS PER AS 3660 - 2004 & AS3600 . 12009 (A)&(B)
6. ALL PROPOSED WORKS TO BE APPROVED BY A LICENCED CERTIFIER PRIOR TO

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CERTIFICATION
ISSUE
MONDAY, 24 MARCH
2025

CLIENT:
DC HOUSE TEAM
SITE ADDRESS:
11 James St, Gracemere, QLD 4702

FLOOR PLAN NOTES

SOME PARTS MAY NOT BE RELEVANT TO THIS JOB

1. DO NOT SCALE FROM PLAN & DO NOT SCALE WINDOW &
DOOR LOCATIONS FROM PLAN. IF IN DOUBT CONTACT THE
DESIGNER OR BUILDER.

2. THE DEVELOPMENT WILL COMPLY WITH THE LOCAL ENVIRONMENT PROTECTION AUTHORITY, ENVIRONMENT PROTECTION GUIDELINES FOR CONSTRUCTION AND LAND DEVELOPMENT IN THE AREA AS REQUIRED.

3. WINDOW OPENING SIZES ARE TO BE CHECKED PRIOR TO MANUFACTURE. CONTACT THIS OFFICE IF IN DOUBT OF WINDOW POSITION.

4. ALL NEW OR REPLACED WINDOWS ARE DIMENSIONED, EXISTING UNCHANGED WINDOWS ARE LEFT UNDIMENSIONED.

5. 4 STAR WELS RATING TAPS AND FITTINGS ARE TO BE USED FOR KITCHEN, BATHROOMS AND LAUNDRY.
6. TOILETS ARE TO BE DUAL FLUSH WITH A MINIMUM WELS RATING OF 4 STARS. SHOWER HEAD TO BE

MINIMUM 3 STARS WELS RATING.
7. PROVIDE LIFT OFF HINGES TO TOILET DOOR.
8. ROBE SHELVES AT 1700MM ABOVE FLOOR WITH RAIL UNDER. WALK IN ROBES AT 1800MM / 2100 FOR DOUBLE RAIL LINEN, PANTRY AND STORES TO HAVE A 4 NUMBERS OF SHELVES. BROOM CUPBOARDS SHELF AT 1600MM.

9. SQ. SET DOOR HAMPERS ARE TO BE SQUARE SET AND 2100MM HEAD HEIGHT OR TO MATCH INTERNAL DOOR HEIGHTS.

10. ALL HANDRAILS TO BE FINISHED AT 1050MM ABOVE FINISHED FLOOR LEVEL. $\,$

11. PROVIDE A GPO AND COLD WATER CONNECTION TO DISHWASHER SPACE. PROVIDE GPO TO FRIDGE & RANGEHOOD SPACE.

12. 70MM WALL FRAMES TO HAVE R1.5 WALL BATTS & 90MM FRAMES TO HAVE R2.0 WALL BATTS, FLAT CEILINGS TO HAVE R3.0 CEILING BATTS & PITCHED CEILINGS TO HAVE R4.0 BATTS - INSULATION REQUIREMENTS MAY VARY WITH WALL FINISHES/COLOURS AND SUBJECT TO ENERGY REPORT.

13. DOWNPIPES TO BE MAXIMUM 12M SPACING AND ADJACENT TO ALL VALLEY INTERSECTIONS.

14. DRAINAGE TO BE IN ACCORDANCE WITH PART 3 OF THE BCA. POINT OF DISCHARGE TO MEET LOCAL AUTHORITY REQUIREMENTS.

15. ALL NEW ENTRY DOOR FURNITURE IS TO BE FIRE SAFETY RATED, IT IS HIGHLY RECOMMENDED FOR BUILDER & OWNERS TO ADDRESS EXISTING ENTRY/EXIT DOOR FURNITURE FOR SAFETY RATING.

16. ALL BATHROOMS TO HAVE FLOOR WASTES IN ACCORDANCE WITH AS3740 OR SHOWERS TO HAVE MINIMUM 900MM WIDE PANEL.

17. STRUCTURES WITHIN 100 METRES OF OCEAN TO HAVE COLORBOND STAINLESS STEEL ROOF SHEETING OR EQUIVALENT, AND WITHIN 100 - 200 METRES TO HAVE COLORBOND ULTRA OR EQUIVALENT. METAL WALL CLADDING WITHIN 500 METRES OF OCEANT TO HAVE COLORBOND STAINLESS STEEL OR EQUIVALENT, AND WITHIN 500 METRES TO 1KM TO HAVE COLORBOND ULTRA.

18. FLOOR WASTES TO BATHROOMS TO AS3740, OR SHOWERS TO HAVE MINIMUM 900MM GLASS PANEL OR TILED WALL FRAME

ROCKHAMPTON REGIONAL COUNCIL

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6,740

0 6,560 - KITCHEN / DINING / LIVING

1 1,900 90 1,035 90 3,445 90

3,025 - BED 3 90 1,025 90 2,330 - BATH 90

1 3,000 1


R3.0 BATTS TO CEILING
ALL WALLS AND ROOF FRAME TO HAVE R.10
SISALATION WRAP / R1.0 SLAB INSULATION (OPT.)
WEATHER SEALS TO ALL DOORS & WINDOWS
IF THE LIP IS ROUNDED OR BEVELLED OR BE RAMPED
WITH THE DEPTH OF THE DOOR FRAME AND HAVE A GRADIENT
1.8 MAX
NOTE:
- KITCHENS ARE FOR VISUAL PURPOSES ONLY
- DECKING BOARDS TO HAVE 8mm MINIMUM GAPS IN BETWEEN BOARDS


WALL CLADDING NOTE


WALL & CEILING INSULATION

PROVIDE CAVITY BATTEN BETWEEN CLADDING AND FRAME - SEE DETAILS PAGE ALL CLADDINGS TO BE INSTALLED TO MANUFACTURER SPECIFICATIONS

R.20 BATTS TO EXTERNALL WALL 70 & 90MM FRAMES

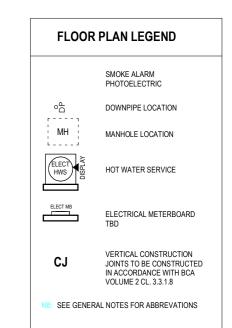

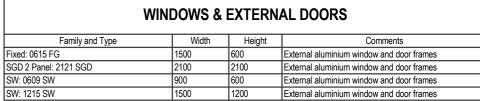

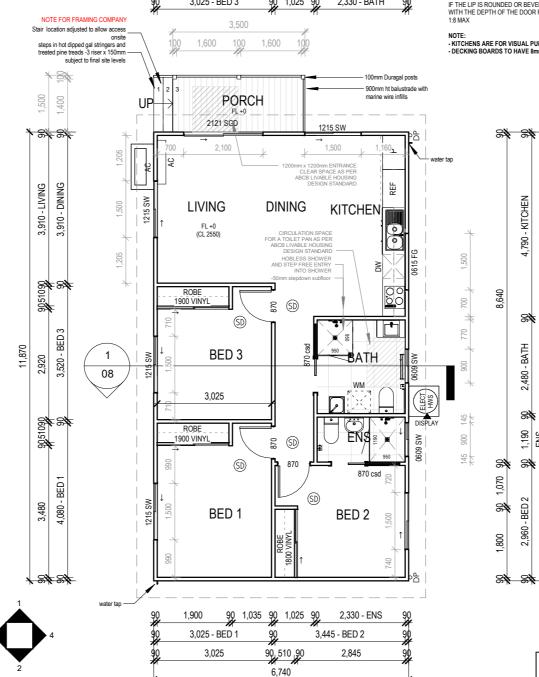

Ground Floor Plan

1 · 100

PREPARED FOR EXCLUSIVE USE FOR DC HOUSE

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23-25 Prosper Crescent Burleigh Heads 4220

BCC LIC 13 10510

ACN 640 265 974 ABN 19 604 265 974

ACN 040 200 9/4 ABN 19 004 200 9/4

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REVISION E
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2025

CLIENT:

DC HOUSE TEAM


SITE ADDRESS:
11 James St, Gracemere, QLD 4702

	DRAWING TITLE:	JOB NO: J2094		DESIGN:
VI .	GROUND FLOOR PLAN	SHEET NO: 05		DOI! 40
)2	SCALE: 1:100 A3	DRAWN BY: KA/MT	CHECKED BY:	DCH 18


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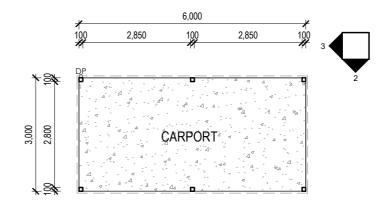
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Elevation - A



Elevation - B 1:100

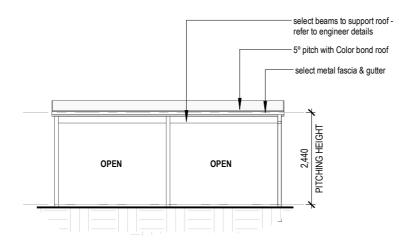


Proposed Carport Plan

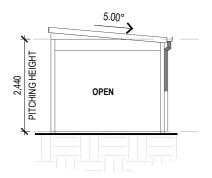WALL & CEILING INSULATION

R.20 BATTS TO EXTERNALL WALL 70 & 90MM FRAMES R3.0 BATTS TO CEILING ALL WALLS AND ROOF FRAME TO HAVE R.10 SISALATION WRAP / R1.0 SLAB INSULATION (OPT.) WEATHER SEALS TO ALL DOORS & WINDOWS NOTE: FINAL BUILDING COLOURS MAY EFFECT R-VALUES REFER ENERGY REPORT

WALL CLADDING NOTE

PROVIDE CAVITY BATTEN BETWEEN CLADDING AND FRAME - SEE DETAILS PAGE ALL CLADDINGS TO BE INSTALLED TO MANUFACTURER SPECIFICATIONS

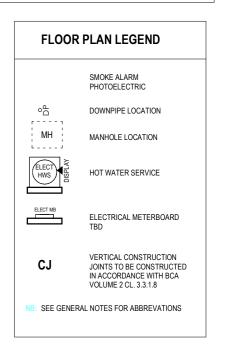

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DC House 23-25 Prosper Crescent Burleigh Heads 4220 OBCC LIC 1310310
ACN 640 265 974 ARN 19 RN 4 98-974

PREPARED FOR EXCLUSIVE USE FOR DC HOUSE

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DRAWING TITLE:		JOB NO: J2094		DESIGN:
CARPORT PLAN		SHEET NO: 06		DOI: 40
	SCALE: A3	DRAWN BY:	CHECKED BY:	DCH 18


EST EXTERNAL WALLS Length Area m2 Function Family and Type Comments Basic Wall: Baseboards 150 x 25mm Plinth H4 Treated Pine Sawn Wet Basic Wall: Baseboards 11780 150 x 25mm Plinth H4 Exterior Treated Pine Sawn Wet Basic Wall: Cladding - 90 FC 6650 37.05 standard select 7.5mm Horizontal Cladding FC smooth weatherboard Basic Wall: Cladding - 90 FC 11780 68.29 standard select 7.5mm Exterior Horizontal Cladding FC smooth weatherboard 116.42


Grand total


TRIMDEK® cladding has a subtle square-fluted profile, available in long lengths, so on most jobs you can have one sheet from ridge to gutter without end-laps.

TRIMDEK® cladding is made of high strength steel and despite its lightness, provides excellent spanning and rainwater carrying capacity.

The strength, spanning ability, lightness and rigidity of TRIMDEK® cladding permits wide support spacings to

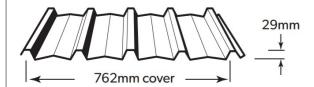

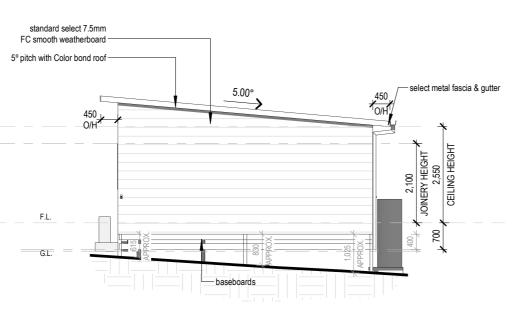

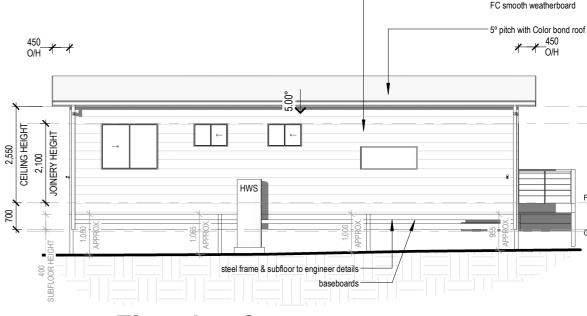

standard select 7.5mm

5° pitch with Color bond roof

standard select 7.5mm

2,550 CEILING HEIGHT

T 2,100 JOINERY HEIGHT

O/H

Elevation C

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5° pitch with Color bond roof standard select 7.5mm FC smooth weatherboard steel frame & subfloor to engineer details

Elevation D

AC EXT

Elevation B

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