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LOCALITY PLAN

NOT TO SCALE

SERVICES LEGEND

- T — — — T — — — T — — — OPTICAL FIBRE BELOW GROUND
- — — E — — — E — — — BELOW GROUND ELECTRICAL SUPPLY
- FE — — — FE — — — ABOVE GROUND FEEDER CABLES
- - - FE - - - FE - - - BELOW GROUND FEEDER CABLES

ROCKHAMPTON REGIONAL COUNCIL
APPROVED PLANS
These plans are approved subject to the current conditions of approval associated with
Development Permit No.: D/123-2023
Dated: 15 December 2023

SITE ACCESS
SCALE 1:500
5m 0 5m 10m 15m 20m 25m SCALE 1:500

PROPERTY DESCRIPTION		SITE STRUCTURE CO-ORDINATES (GDA94)	
PART OF LOT 8 ON RP 801164		GPS READING ACCURACY: ±10m	
PARISH: N/A		CENTER OF MONOPOLE	
COUNTY: N/A		LATITUDE	-23.37578° (GDA94)
		LONGITUDE	150.50246° (GDA94)



TO BE READ IN CONJUNCTION WITH SHEETS S1-1, S1-2, S3 & S3-1.

ORDER	DRAWN	CHKD	AMENDMENT	EXAM	APPD	DATE	ISS
4015083.01	SI	AH	PRELIM - 30095327WO005 VPL - LTE700/1800/2100/2600/5G3.6/5G.85	MR	RO	03.03.22	1
BTS-170	BMM	PE	PRELIMINARY - 30103604WO6BMM - LAYOUT AMENDED	JG	KB	31.08.23	2


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AMPLITEL
Part of the Telstra Group

TOWER AMS SITE QLD006151
ROCKHAMPTON CITY NORTH
SITE ACCESS & LOCALITY PLAN
45-49 GEORGE ST, ROCKHAMPTON CITY, QLD 4700

DWG NO. **QLD006151**

SHT NO. **S1**

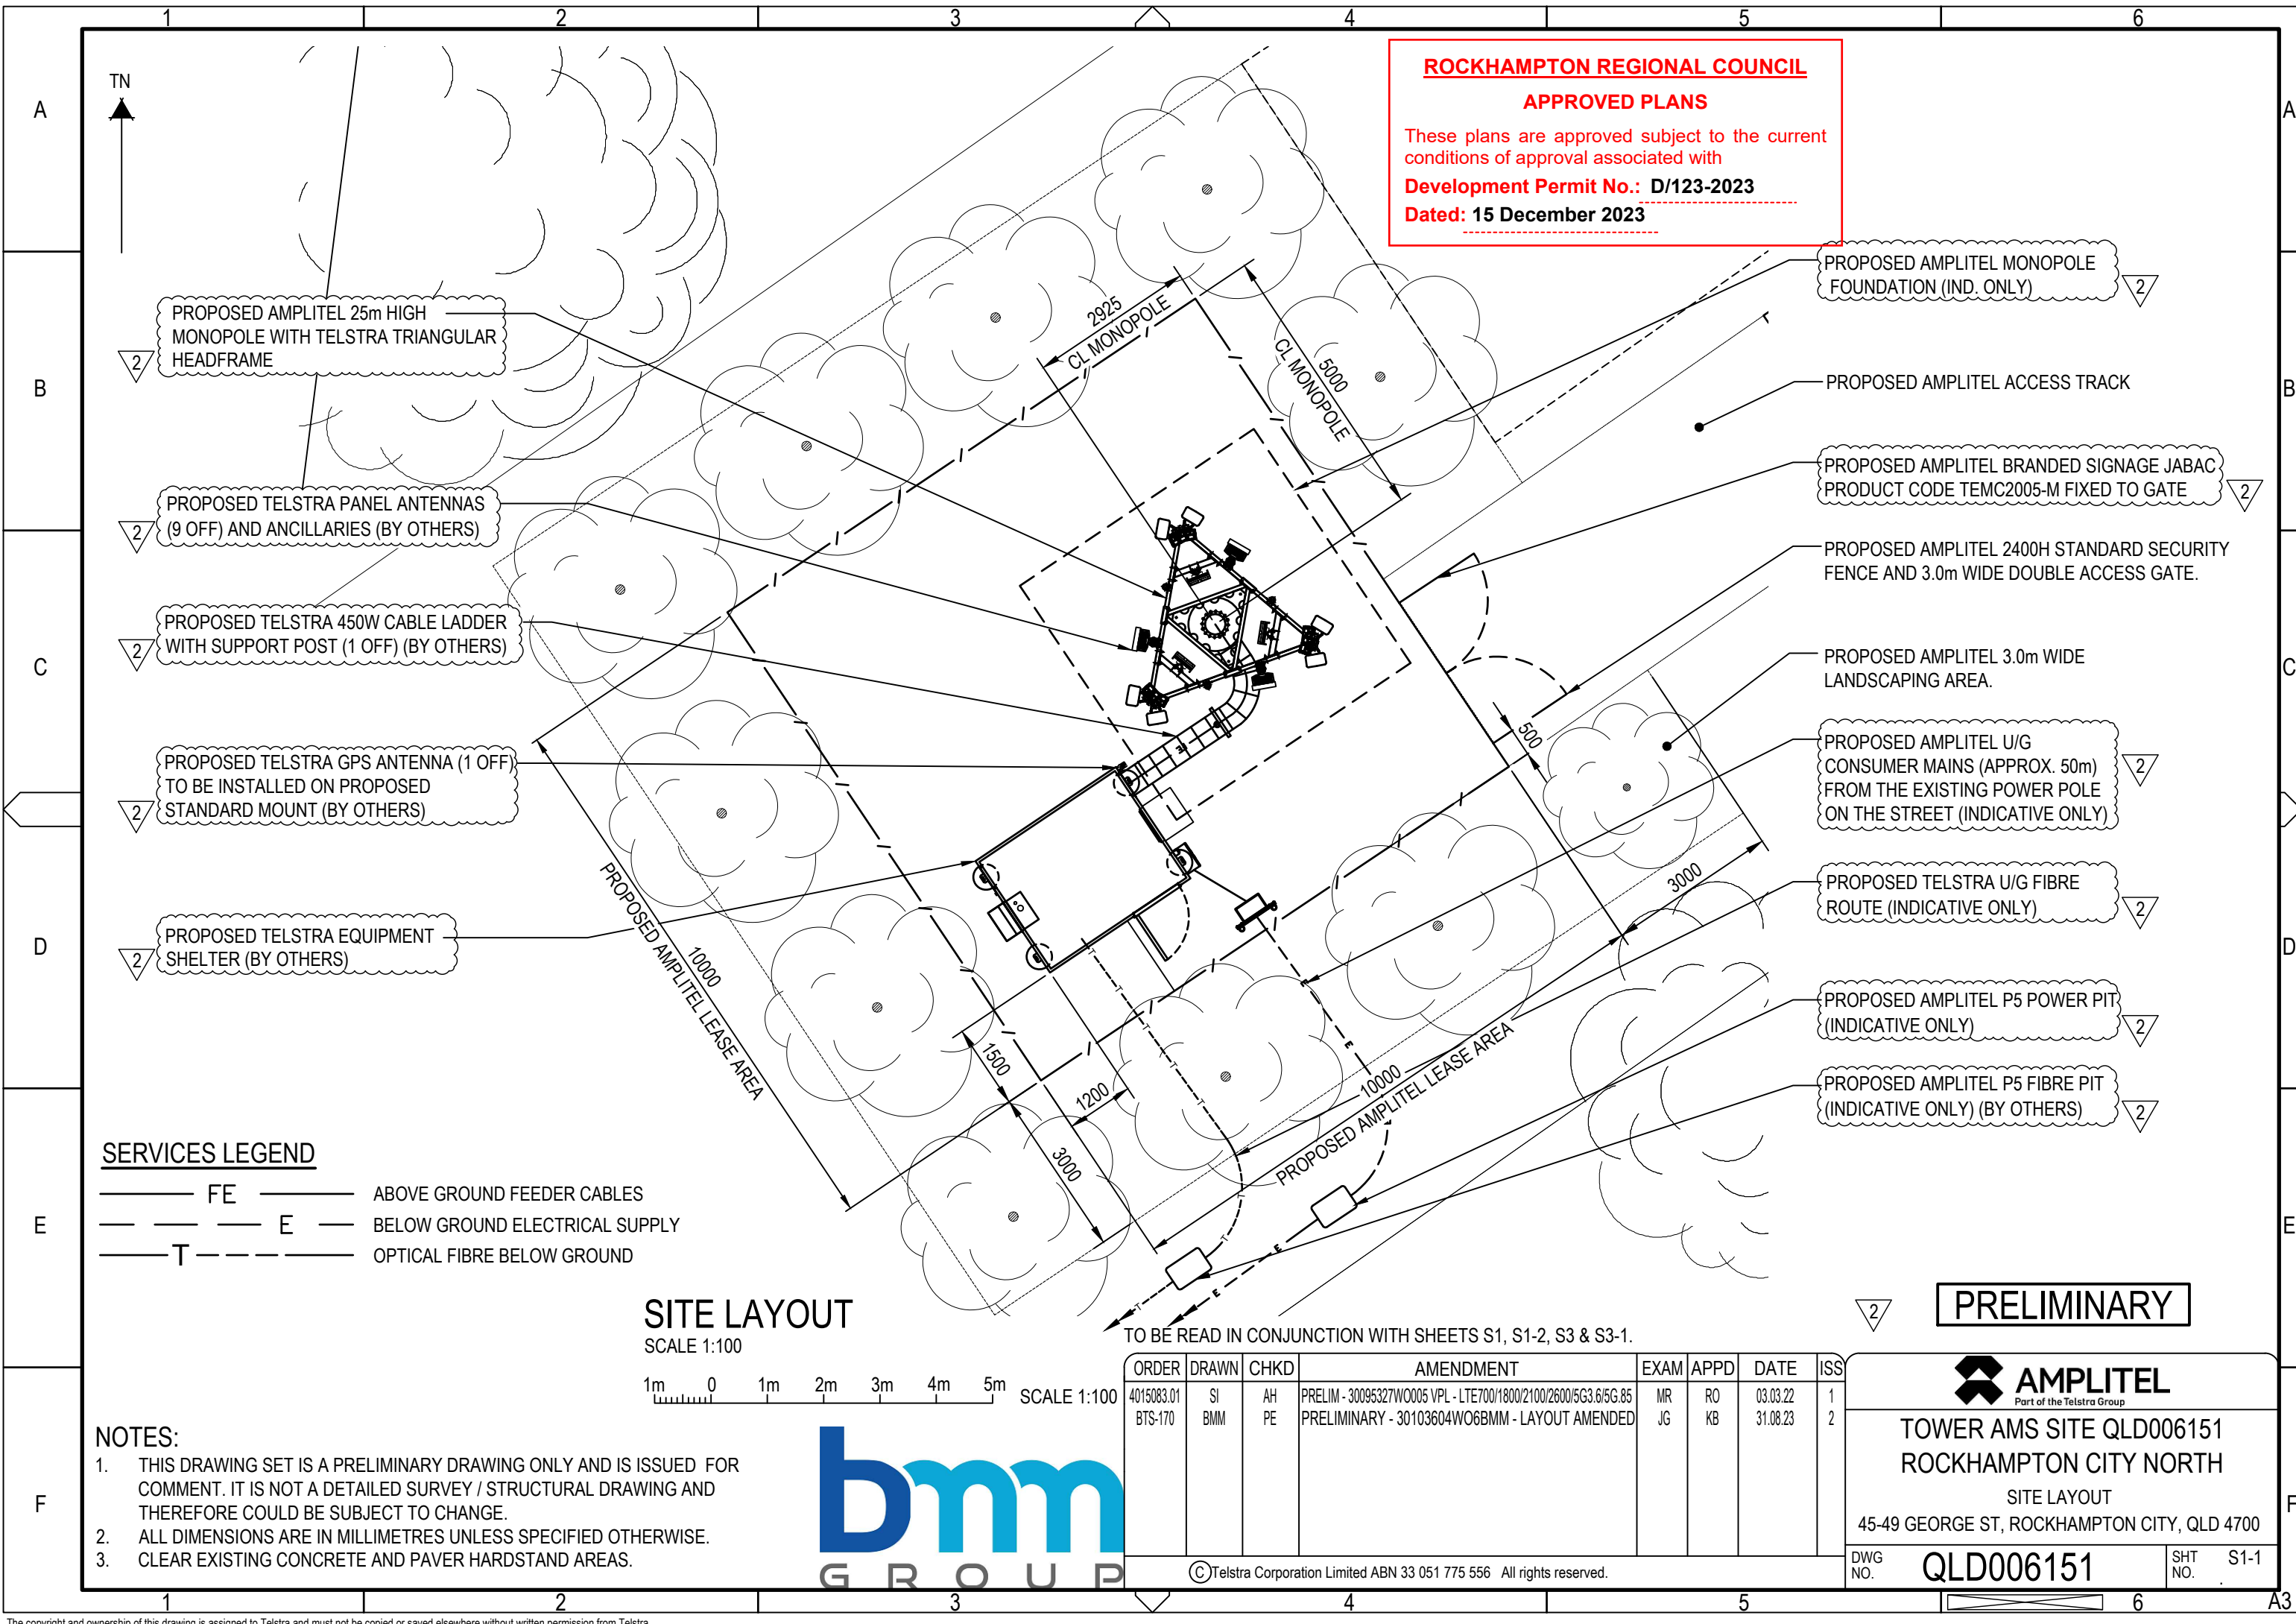

ROCKHAMPTON REGIONAL COUNCIL
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PROPOSED AMPLITEL 25m HIGH MONOPOLE WITH TELSTRA TRIANGULAR HEADFRAME

PROPOSED TELSTRA PANEL ANTENNAS (9 OFF) AND ANCILLARIES (BY OTHERS)

PROPOSED TELSTRA 450W CABLE LADDER WITH SUPPORT POST (1 OFF) (BY OTHERS)

PROPOSED TELSTRA GPS ANTENNA (1 OFF) TO BE INSTALLED ON PROPOSED STANDARD MOUNT (BY OTHERS)

PROPOSED TELSTRA EQUIPMENT SHELTER (BY OTHERS)

PROPOSED AMPLITEL MONOPOLE FOUNDATION (IND. ONLY)

PROPOSED AMPLITEL ACCESS TRACK

PROPOSED AMPLITEL BRANDED SIGNAGE JABAC PRODUCT CODE TEMC2005-M FIXED TO GATE

PROPOSED AMPLITEL 2400H STANDARD SECURITY FENCE AND 3.0m WIDE DOUBLE ACCESS GATE.

PROPOSED AMPLITEL 3.0m WIDE LANDSCAPING AREA.

PROPOSED AMPLITEL U/G CONSUMER MAINS (APPROX. 50m) FROM THE EXISTING POWER POLE ON THE STREET (INDICATIVE ONLY)

PROPOSED TELSTRA U/G FIBRE ROUTE (INDICATIVE ONLY)


PROPOSED AMPLITEL P5 POWER PIT (INDICATIVE ONLY)

PROPOSED AMPLITEL P5 FIBRE PIT (INDICATIVE ONLY) (BY OTHERS)

SERVICES LEGEND

FE — ABOVE GROUND FEEDER CABLES
E — BELOW GROUND ELECTRICAL SUPPLY
T — OPTICAL FIBRE BELOW GROUND

SITE LAYOUT
SCALE 1:100

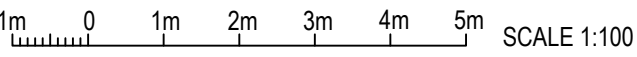

NOTES:

- THIS DRAWING SET IS A PRELIMINARY DRAWING ONLY AND IS ISSUED FOR COMMENT. IT IS NOT A DETAILED SURVEY / STRUCTURAL DRAWING AND THEREFORE COULD BE SUBJECT TO CHANGE.
- ALL DIMENSIONS ARE IN MILLIMETRES UNLESS SPECIFIED OTHERWISE.
- CLEAR EXISTING CONCRETE AND PAVER HARDSTAND AREAS.



TO BE READ IN CONJUNCTION WITH SHEETS S1, S1-2, S3 & S3-1.

ORDER	DRAWN	CHKD	AMENDMENT	EXAM	APPD	DATE	ISS
4015083.01	SI	AH	PRELIM - 30095327WO005 VPL - LTE700/1800/2100/2600/5G3.6/5G.85	MR	RO	03.03.22	1
BTS-170	BMM	PE	PRELIMINARY - 30103604WO6BMM - LAYOUT AMENDED	JG	KB	31.08.23	2

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PRELIMINARY



TOWER AMS SITE QLD006151
ROCKHAMPTON CITY NORTH
SITE LAYOUT
45-49 GEORGE ST, ROCKHAMPTON CITY, QLD 4700

DWG NO. **QLD006151** SHT NO. **S1-1**

NOTES:

1. THIS DRAWING SET IS A PRELIMINARY DRAWING ONLY AND IS ISSUED FOR COMMENT. IT IS NOT A DETAILED SURVEY / STRUCTURAL DRAWING AND THEREFORE COULD BE SUBJECT TO CHANGE.
2. ALL DIMENSIONS ARE IN MILLIMETRES UNLESS SPECIFIED.

- ▽ E.L. 26.3m (±100mm)
OVERALL HEIGHT
- ▽ E.L. 25.67m (±100mm)
C/L PROPOSED TELSTRA PANEL ANTENNAS (3 OFF) (BY OTHERS)
- ▽ E.L. 25.0m (±100mm)
TOP OF PROPOSED AMPLITEL MONOPOLE
C/L PROPOSED TELSTRA PANEL ANTENNAS (6 OFF)
AND ANCILLARIES (BY OTHERS)

PROPOSED AMPLITEL 25.0m HIGH MONOPOLE

PROPOSED TELSTRA FEEDERS TO RUN INSIDE MONOPOLE (BY OTHERS)

ROCKHAMPTON REGIONAL COUNCIL
APPROVED PLANS

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PROPOSED TELSTRA 450W ELEVATED CABLE LADDER WITH SUPPORT POST (1 OFF) (BY OTHERS)

PROPOSED TELSTRA GPS ANTENNA (1 OFF) TO BE INSTALLED ON PROPOSED STANDARD MOUNT (BY OTHERS)

PROPOSED TELSTRA EQUIPMENT SHELTER (BY OTHERS)

PROPOSED AMPLITEL 2400H STANDARD SECURITY FENCE AND DOUBLE ACCESS GATE.

PROPOSED AMPLITEL 3.0m WIDE LANDSCAPING AREA.

E.L. 00.0m (±100mm) RL 13.0m A.H.D.
GROUND LEVEL

PROPOSED TELSTRA U/G FIBRE ROUTE (INDICATIVE ONLY)

PROPOSED AMPLITEL U/G MAINS ROUTE (APPROX. 50m) FROM THE EXISTING POWER POLE ON THE STREET (INDICATIVE ONLY)

PROPOSED AMPLITEL MONOPOLE FOUNDATION (IND. ONLY)

SOUTH EAST ELEVATION

SCALE 1:100
1m 0 1m 2m 3m 4m 5m SCALE 1:100

PRELIMINARY

TO BE READ IN CONJUNCTION WITH SHEETS S1, S1-1, S3 & S3-1.

ORDER	DRAWN	CHKD	AMENDMENT	EXAM	APPD	DATE	ISS
4015083.01	SI	AH	PRELIM - 30095327W0005 VPL - LTE700/1800/2100/2600/5G3.6/5G.85	MIR	RO	03.03.22	1
BTS-170	BMM	PE	PRELIMINARY - 30103604W06BMM - LAYOUT AMENDED	JG	KB	31.08.23	2



TOWER AMS SITE QLD006151
ROCKHAMPTON CITY NORTH

SOUTH EAST ELEVATION
45-49 GEORGE ST, ROCKHAMPTON CITY, QLD 4700

DWG NO. **QLD006151**

SHT NO. **S3**



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