SITE GENERAL NOTES:

1. WRITTEN DIMENSIONS TAKE PRECEDENCE OVER SCALE.

ADDRESS:

SITE AREA:

PARISH:

LOT NUMBER:

PLAN NUMBER:

- 2. BUILDER TO VERIFY ALL BOUNDARY CLEARANCES AND SITE SET OUT DIMENSIONS PRIOR TO COMMENCEMENT OF CONSTRUCTION.
- 3. LEVELS AND CONTOURS ARE BASED ON ASSUMED DATUM.
- 4. VEHICULAR CROSS OVERS TO BE CONSTRUCTED AS PER LOCAL COUNCIL REQUIREMENTS AND/OR APPROVAL. 5. THIS SITE PLAN IS A TRANSCRIPTION OF THE ORIGINAL CONTOUR/ID SURVEY OR SITE PLAN. THE BUILDER AND SUB-CONTRACTORS ARE TO VERIFY ALL INFORMATION CONTAINED HEREIN PRIOR TO SITE START AND ANY DISCREPANCY RESOLVE WITH THIS OFFICE PRIOR TO CONSTRUCTION. 6. IT IS RECOMMENDED TO OBTAIN A NEW
- CONTOUR AND/OR IDENTIFICATION SURVEY PLAN PRIOR TO COMMENCEMENT OF WORK. 7. SEWER TO HOUSE CONNECTION AND WATER MAIN TO HOUSE CONNECTION PLOTTED FROM GCCC INFRASTRUCTURE ASSET MAPPING - INDICATIVE ONLY, SUBJECT TO SURVEY OR SERVICE LOCATION

SITE PREPARATION & DRAINAGE NOTES:

1. ROOFWATER TO BE PIPED VIA 100mm & PVC PIPE TO COUNCIL STORMWATER DRAINAGE SYSTEM OR ON SITE RAIN WATER TANKS IF APPLICABLE, WITH OVERFLOW TO DIRECT TO RUBBLE PITS OR COUNCIL DISCHARGE SYSTEM AS PER APPROVAL REQUIREMENTS. 2. ROOF AND SURFACE WATER TO COMPLY WITH COUNCIL PLUMBING AND DRAINAGE SERVICES CONDITIONS OF APPROVAL. 3. ALL HOUSEHOLD SEWER AND WASTE TO BE DISCHARGED TO COUNCIL SEWER SYSTEM OR ON SITE SEWERAGE FACILITY IF APPLICABLE - OSSF TO BE REVIEWED BY A QUALIFIED CONSULTANT 4. SITE CLASSIFICATION AND FOOTING/SLAB

PREPARATION REFER NCC VOL 2. PART 3.2. 5. ALL GUTTERS AND DOWNPIPES TO ADHERE TO NCC VOL 2. PART 3.5.2.

6. ON SITE RAIN WATER HARVESTING WHERE NOT DIRECT LINES FROM ROOF/GUTTER TO HAVE CHARGED LINES. REFER MANUFACTURER INSTALLATION & SPECIFICATIONS.

7. ALL RETAINING WALLS GREATER THAN 1,000 IN HEIGHT TO BE DESIGNED BY A REGISTERED PRACTICING STRUCTURAL ENGINEER (RPEQ).

TERMITE PROTECTION:

1. TERMITE PROTECTION IS A VISUAL BARRIER SYSTEM WITH APPROVED COLLARS AT PENETRATIONS IN ACCORDANCE WITH AS3660 2004 & AS3600.1/2009. - REFER TO CONDITIONS OF APPROVAL

2. ALL TERMITE PROTECTION TO BE INSTALLED IN ACCORDANCE WITH MANUFACTURERS SPECIFICATIONS

REAL PROPERTY DESCRIPTION

259 Rockonia Rd, Koongal, QLD 4701 805m²

RP606861

COUNTY: Rockhampton City Council LOCAL AUTHORITY: 332.52m² **BUILDING AREA:** SITE COVERAGE:

41%

SURVEYING NOTE

CONTOUR / DETAIL SURVEY / LEVELS NOT PROVIDED BY

IT IS RECOMMENDED TO CARRY OUT A DETAIL SURVEY PRIOR TO FINALISING DESIGN, AND ANY DISCREPANCIES RESOLVE WITH THIS OFFICE.

IT IS THE BUILDER'S RESPONSIBILITY TO CONDUCT AN I DENT SURVEY AND SEWER LOCATION PRIOR TO CONSTRUCTION


DUAL OCCUPANCY NOTES

- car parking spaces to comply with AS2890.1 2 covered and 2 uncovered setbacks in accordance with QDC MP1.3
- prior to construction builder to locate sewer line and ensure footing setback is 1200mm minimum from sewer, clearance above sewer connection 2500mm

to comply with QDC part MP1.4

- any alteration to existing vehicular crossovers to comply with the local authority

requirements

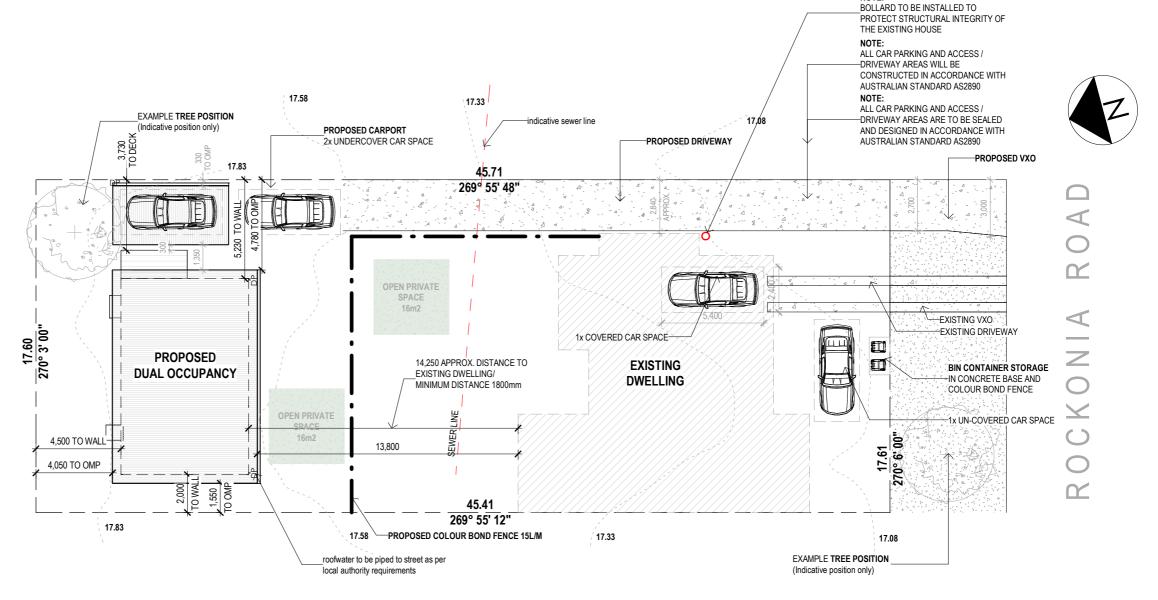



ROCKHAMPTON REGIONAL COUNCIL APPROVED PLANS

These plans are approved subject to the current conditions of approval associated with

DCH-8

Development Permit No.: D/49-2025

Dated: 27 August 2025

TOUSE 23-25 Prosper Crescent Burleigh Heads 4220 OBCC LIC 1310310

Version: 1. Version Date: 24/07/2025

PREPARED FOR EXCLUSIVE USE FOR DC HOUSE Ph 07 5635 8990 team@dchouse.com.au

GENERAL NOTES:

REFRIGIRATORS, DISHWASHERS, FREEZERS AND WASHING MACHINE SYMBOLS ARE FOR POSITIONING PURPOSES ONLY

WINDOWS DIMENSIONED AS HEIGHT X WIDTH

1. BUILDER TO VERIFY ALL DETAILS AND DIMENSIONS PRIOR TO SITE START 2. WRITTEN DIMENSIONS TAKE PRECEDENCE OVER SCALE

B. DO NOT SCALE FROM PLAN

4. ALL WORK TO COMPLY WITH THE PROVISIONS OF THE BUILDING CODE OF AUSTRALIA, AUSTRALIAN STANDARDS AND ANY BYLAWS OR REQUIREMENTS OF THE LOCAL AUTHOR 5. TERMITE PROTECTION: TREATMENT AS PER AS 3660 - 2004 & AS3600. 1/2009 (A)&(B) 6. ALL PROPOSED WORKS TO BE APPROVED BY A LICENCED CERTIFIER PRIOR TO CONSTRUCTION & ALL STRUCTURAL WORK SUBJECT TO ENGINEER DESIGN & SPECS

JOB DESCRIPTION CLIENT PROPOSED DUAL OCCUPANCY DC HOUSE TEAM REVISION: ISSUE / DATE: REVISION F CERTIFICATION SITE ADDRESS REVISION F TUESDAY,22 JULY 259 Rockonia Rd, Koongal, QLD 4701 REVISION G 2025

JOB NO: DRAWING TITLE: DESIGN: J3631 SHEET NO: SITE 04 DRAWN BY CHECKED BY: 1:200 A3 KΑ

© 2023 REPRODUCTION IN PART OR WHOLE IS STRICTL Document Set ID: 41122588

FLOOR PLAN NOTES

SOME PARTS MAY NOT BE RELEVANT TO THIS JOB 1. DO NOT SCALE FROM PLAN & DO NOT SCALE WINDOW & DOOR LOCATIONS FROM PLAN. IF IN DOUBT CONTACT THE DESIGNER OR BUILDER.

2. THE DEVELOPMENT WILL COMPLY WITH THE LOCAL ENVIRONMENT PROTECTION AUTHORITY, ENVIRONMENT PROTECTION GUIDELINES FOR CONSTRUCTION AND LAND DEVELOPMENT IN THE AREA AS REQUIRED

3. WINDOW OPENING SIZES ARE TO BE CHECKED PRIOR TO MANUFACTURE. CONTACT THIS OFFICE IF IN DOUBT OF WINDOW POSITION.

4. ALL NEW OR REPLACED WINDOWS ARE DIMENSIONED, EXISTING UNCHANGED WINDOWS ARE LEFT UN-

5. 4 STAR WELS RATING TAPS AND FITTINGS ARE TO BE USED FOR KITCHEN, BATHROOMS AND LAUNDRY. 6. TOILETS ARE TO BE DUAL FLUSH WITH A MINIMUM WELS RATING OF 4 STARS. SHOWER HEAD TO BE MINIMUM 3 STARS WELS RATING.

7. PROVIDE LIFT OFF HINGES TO TOILET DOOR. 8. ROBE SHELVES AT 1700MM ABOVE FLOOR WITH RAIL UNDER. WALK IN ROBES AT 1800MM / 2100 FOR DOUBLE RAIL LINEN, PANTRY AND STORES TO HAVE A 4 NUMBERS OF SHELVES. BROOM CUPBOARDS SHELF AT 1600MM. 9. SQ. SET DOOR HAMPERS ARE TO BE SQUARE SET AND 2100MM HEAD HEIGHT OR TO MATCH INTERNAL DOOR

10. ALL HANDRAILS TO BE FINISHED AT 1050MM ABOVE FINISHED FLOOR LEVEL.

11. PROVIDE A GPO AND COLD WATER CONNECTION TO DISHWASHER SPACE. PROVIDE GPO TO FRIDGE & RANGEHOOD SPACE.

12. 70MM WALL FRAMES TO HAVE R1.5 WALL BATTS & 90MM FRAMES TO HAVE R2.5 WALL BATTS, FLAT CEILINGS TO HAVE R3.0 CEILING BATTS & PITCHED CEILINGS TO HAVE R4.0 BATTS - INSULATION REQUIREMENTS MAY VARY WITH WALL FINISHES/COLOURS AND SUBJECT TO **ENERGY REPORT**

13. DOWNPIPES TO BE MAXIMUM 12M SPACING AND ADJACENT TO ALL VALLEY INTERSECTIONS.

14. DRAINAGE TO BE IN ACCORDANCE WITH PART 3 OF THE BCA. POINT OF DISCHARGE TO MEET LOCAL AUTHORITY REQUIREMENTS.


15. ALL NEW ENTRY DOOR FURNITURE IS TO BE FIRE SAFETY RATED, IT IS HIGHLY RECOMMENDED FOR BUILDER & OWNERS TO ADDRESS EXISTING ENTRY/EXIT DOOR FURNITURE FOR SAFETY RATING.

16. ALL BATHROOMS TO HAVE FLOOR WASTES IN ACCORDANCE WITH AS3740 OR SHOWERS TO HAVE MINIMUM 900MM WIDE PANEL.

17. STRUCTURES WITHIN 100 METRES OF OCEAN TO HAVE COLORBOND STAINLESS STEEL ROOF SHEETING OR FOUIVALENT AND WITHIN 100 - 200 METRES TO HAVE COLORBOND ULTRA OR EQUIVALENT. METAL WALL CLADDING WITHIN 500 METRES OF OCEANT TO HAVE COLORBOND STAINLESS STEEL OR EQUIVALENT, AND WITHIN 500 METRES TO 1KM TO HAVE COLORBOND

18. FLOOR WASTES TO BATHROOMS TO AS3740, OR SHOWERS TO HAVE MINIMUM 900MM GLASS PANEL OR TILED WALL FRAME

Version: 1. Version Date: 24/07/2025

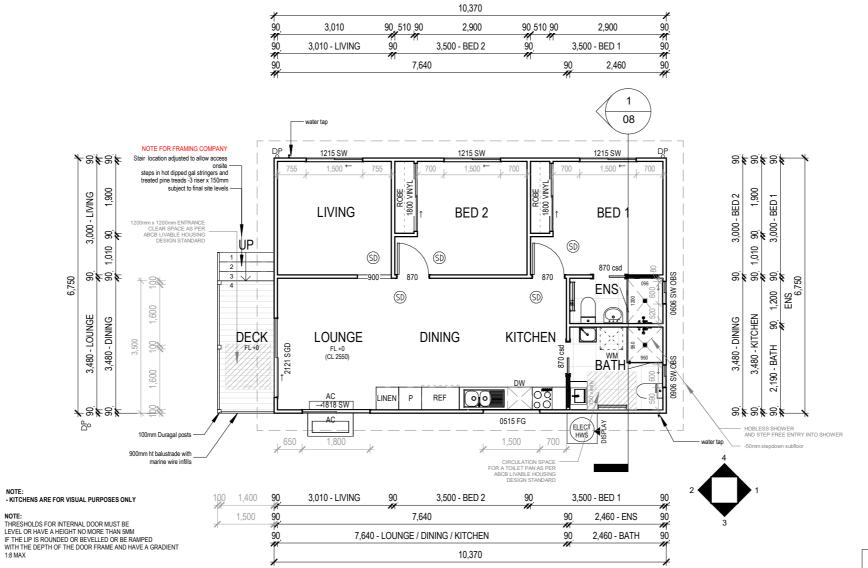


WALL & CEILING INSULATION

R2.5 BATTS TO EXTERNALL WALL 70 & 90MM FRAMES R3 0 BATTS TO CEILING ALL WALLS AND ROOF FRAME TO HAVE R.10 SISALATION WRAP / R1.0 SLAB INSULATION (OPT.) WEATHER SEALS TO ALL DOORS & WINDOWS NOTE: FINAL BUILDING COLOURS MAY EFFECT R-VALUES REFER ENERGY REPORT

WALL CLADDING NOTE

PROVIDE CAVITY BATTEN BETWEEN CLADDING AND FRAME - SEE DETAILS PAGE ALL CLADDINGS TO BE INSTALLED TO MANUFACTURER SPECIFICATIONS

FLOOR PLAN LEGEND SMOKE ALARM PHOTOELECTRIC 암 DOWNPIPE LOCATION MH MANHOLE LOCATION HOT WATER SERVICE ELECTRICAL METERBOARD VERTICAL CONSTRUCTION CJ JOINTS TO BE CONSTRUCTED IN ACCORDANCE WITH BCA VOLUME 2 CL. 3.3.1.8 SEE GENERAL NOTES FOR ABBREVATIONS

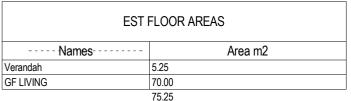

External aluminium window and door frames

External aluminium window and door frames

Ground Floor Plan

1:100

ROCKHAMPTON REGIONAL COUNCIL

APPROVED PLANS

These plans are approved subject to the current conditions of approval associated with

Development Permit No.: D/49-2025

Dated: 27 August 2025

WINDOWS & EXTERNAL DOORS Family and Type Width Fixed: 0515 FG 1500 500 External aluminium window and door frames SGD 2 Panel: 2121 SGD 2100 2100 External aluminium window and door frames SW 4 Panel: 1818 SW 1800 1800 External aluminium window and door frames SW: 0606 SW OBS 600 External aluminium window and door frames

900

1200

600

1500

PREPARED FOR EXCLUSIVE USE FOR DC HOUSE

CONSTRUCTION

23-25 Prosper Crescent Burleigh Heads 4220

OBCC LIC 1310310

ACN 640 265 Prosper Crescent Burleigh Heads 4220

DOORS AND CUPBOARDS DIMENSIONED AS WIDTH © 2023 REPRODUCTION IN PART OR WHOLE IS STRICTL

GENERAL NOTES:

POSITIONING PURPOSES ONLY

REFRIGIRATORS, DISHWASHERS, FREEZERS AND WASHING MACHINE SYMBOLS ARE FOR

B. DO NOT SCALE FROM PLAN WINDOWS DIMENSIONED AS HEIGHT X WIDTH

1. BUILDER TO VERIFY ALL DETAILS AND DIMENSIONS PRIOR TO SITE START 2. WRITTEN DIMENSIONS TAKE PRECEDENCE OVER SCALE

4. ALL WORK TO COMPLY WITH THE PROVISIONS OF THE BUILDING CODE OF AUSTRALIA. AUSTRALIAN STANDARDS AND ANY BYLAWS OR REQUIREMENTS OF THE LOCAL AUTHORITY 5. TERMITE PROTECTION: TREATMENT AS PER AS 3660 - 2004 & AS3600. 1/2009 (A)&(B) 6. <u>ALL PROPOSED WORKS TO BE APPROVED BY A LICENCED CERTIFIER PRIOR TO</u>

CONSTRUCTION & ALL STRUCTURAL WORK SUBJECT TO ENGINEER DESIGN & SPECS

	JOB DESCRIPTION: PROPOSED DUAL OCCUPANCY		CLIENT: DC HOUSE TEAM	
	ISSUE / DATE:	REVISION:	DC HOUSE TEAM	
Y	CERTIFICATION	REVISION E	SITE ADDRESS:	
	TUESDAY,22 JULY	REVISION F	259 Rockonia Rd, Koongal, QLD 4701	s
		REVISION G		

SW: 0906 SW OBS

SW: 1215 SW

DRAWING TITLE:		JOB NO: J3631		DECION	
				DESIGN:	
_	GROUND FLOOR PLAN	SHEET NO: 05		Dalla	
	SCALE: 1:100 A3	DRAWN BY:	CHECKED BY:	DCH-8	

FLOOR PLAN NOTES

SOME PARTS MAY NOT BE RELEVANT TO THIS JOB 1. DO NOT SCALE FROM PLAN & DO NOT SCALE WINDOW & DOOR LOCATIONS FROM PLAN. IF IN DOUBT CONTACT THE DESIGNER OR BUILDER.

2. THE DEVELOPMENT WILL COMPLY WITH THE LOCAL ENVIRONMENT PROTECTION AUTHORITY, ENVIRONMENT PROTECTION GUIDELINES FOR CONSTRUCTION AND LAND DEVELOPMENT IN THE AREA AS REQUIRED.

3. WINDOW OPENING SIZES ARE TO BE CHECKED PRIOR TO MANUFACTURE. CONTACT THIS OFFICE IF IN DOUBT OF WINDOW POSITION.

4. ALL NEW OR REPLACED WINDOWS ARE DIMENSIONED, EXISTING UNCHANGED WINDOWS ARE LEFT UN-

5. 4 STAR WELS RATING TAPS AND FITTINGS ARE TO BE USED FOR KITCHEN, BATHROOMS AND LAUNDRY. 6. TOILETS ARE TO BE DUAL FLUSH WITH A MINIMUM WELS RATING OF 4 STARS. SHOWER HEAD TO BE MINIMUM 3 STARS WELS RATING.

7. PROVIDE LIFT OFF HINGES TO TOILET DOOR. 8. ROBE SHELVES AT 1700MM ABOVE FLOOR WITH RAIL UNDER. WALK IN ROBES AT 1800MM / 2100 FOR DOUBLE RAIL LINEN, PANTRY AND STORES TO HAVE A 4 NUMBERS OF SHELVES. BROOM CUPBOARDS SHELF AT 1600MM. 9. SQ. SET DOOR HAMPERS ARE TO BE SQUARE SET AND 2100MM HEAD HEIGHT OR TO MATCH INTERNAL DOOR

10. ALL HANDRAILS TO BE FINISHED AT 1050MM ABOVE FINISHED FLOOR LEVEL.

11. PROVIDE A GPO AND COLD WATER CONNECTION TO DISHWASHER SPACE. PROVIDE GPO TO FRIDGE & RANGEHOOD SPACE.

12. 70MM WALL FRAMES TO HAVE R1.5 WALL BATTS & 90MM FRAMES TO HAVE R2.0 WALL BATTS, FLAT CEILINGS TO HAVE R3.5 CEILING BATTS & PITCHED CEILINGS TO HAVE R4.0 BATTS - INSULATION REQUIREMENTS MAY VARY WITH WALL FINISHES/COLOURS AND SUBJECT TO ENERGY REPORT.

13. DOWNPIPES TO BE MAXIMUM 12M SPACING AND ADJACENT TO ALL VALLEY INTERSECTIONS.


14. DRAINAGE TO BE IN ACCORDANCE WITH PART 3 OF THE BCA. POINT OF DISCHARGE TO MEET LOCAL AUTHORITY REQUIREMENTS.

15. ALL NEW ENTRY DOOR FURNITURE IS TO BE FIRE SAFETY RATED, IT IS HIGHLY RECOMMENDED FOR BUILDER & OWNERS TO ADDRESS EXISTING ENTRY/EXIT DOOR FURNITURE FOR SAFETY RATING.

16. ALL BATHROOMS TO HAVE FLOOR WASTES IN ACCORDANCE WITH AS3740 OR SHOWERS TO HAVE MINIMUM 900MM WIDE PANEL.

17. STRUCTURES WITHIN 100 METRES OF OCEAN TO HAVE COLORBOND STAINLESS STEEL ROOF SHEETING OR EQUIVALENT, AND WITHIN 100 - 200 METRES TO HAVE COLORBOND ULTRA OR EQUIVALENT. METAL WALL CLADDING WITHIN 500 METRES OF OCEANT TO HAVE COLORBOND STAINLESS STEEL OR EQUIVALENT, AND WITHIN 500 METRES TO 1KM TO HAVE COLORBOND ULTRA.

18. FLOOR WASTES TO BATHROOMS TO AS3740. OR SHOWERS TO HAVE MINIMUM 900MM GLASS PANEL OR TILED WALL FRAME

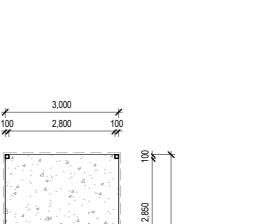


5 8




Proposed Carport Plan

CARPORT

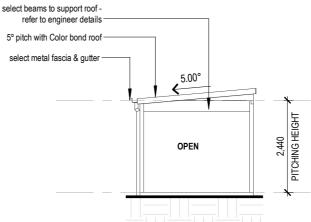



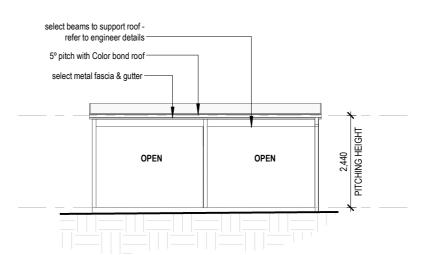

Elevation - B

WALL & CEILING INSULATION

R.20 BATTS TO EXTERNALL WALL 70 & 90MM FRAMES R3.0 BATTS TO CEILING ALL WALLS AND ROOF FRAME TO HAVE R.10 SISALATION WRAP / R1.0 SLAB INSULATION (OPT.) WEATHER SEALS TO ALL DOORS & WINDOWS NOTE: FINAL BUILDING COLOURS MAY EFFECT R-VALUES REFER ENERGY REPORT

WALL CLADDING NOTE

PROVIDE CAVITY BATTEN BETWEEN CLADDING AND FRAME - SEE DETAILS PAGE ALL CLADDINGS TO BE INSTALLED TO MANUFACTURER SPECIFICATIONS

FLOOR PLAN LEGEND SMOKE ALARM (SD) PHOTOELECTRIC 음 DOWNPIPE LOCATION MH MANHOLE LOCATION HOT WATER SERVICE ELECTRICAL METERBOARD VERTICAL CONSTRUCTION CJ JOINTS TO BE CONSTRUCTED IN ACCORDANCE WITH BCA VOLUME 2 CL. 3.3.1.8 SEE GENERAL NOTES FOR ABBREVATIONS

ROCKHAMPTON REGIONAL COUNCIL APPROVED PLANS

These plans are approved subject to the current conditions of approval associated with

Development Permit No.: D/49-2025

Dated: 27 August 2025

Version: 1. Version Date: 24/07/2025

Document Set ID: 41122588

PREPARED FOR EXCLUSIVE USE FOR DC HOUSE

Ph 07 5635 8990 team@dchouse.com.au

REFRIGIRATORS, DISHWASHERS, FREEZERS AND WASHING MACHINE SYMBOLS ARE FOR POSITIONING PURPOSES ONLY

GENERAL NOTES:

WINDOWS DIMENSIONED AS HEIGHT X WIDTH DOORS AND CUPBOARDS DIMENSIONED AS WIDTH


- 1. BUILDER TO VERIFY ALL DETAILS AND DIMENSIONS PRIOR TO SITE START 2. WRITTEN DIMENSIONS TAKE PRECEDENCE OVER SCALE
- B. DO NOT SCALE FROM PLAN
- 4. ALL WORK TO COMPLY WITH THE PROVISIONS OF THE BUILDING CODE OF AUSTRALIA, 4. ALE WORK TO COMPET WITH ENTRY TO STANDARDS AND ANY BYLAWS OR REQUIREMENTS OF THE LOCAL AUTHOR 5. TERMITE PROTECTION: TREATMENT AS PER AS 3660 - 2004 & AS3600. 1/2009 (A)&(B) 6. ALL PROPOSED WORKS TO BE APPROVED BY A LICENCED CERTIFIER PRIOR TO

CONSTRUCTION & ALL STRUCTURAL WORK SUBJECT TO ENGINEER DESIGN & SPECS

JOB DESCRIPTION CLIENT: PROPOSED DUAL OCCUPANCY DC HOUSE TEAM REVISION: ISSUE / DATE: REVISION F CERTIFICATION SITE ADDRESS: REVISION F TUESDAY,22 JULY 259 Rockonia Rd, Koongal, QLD 4701 REVISION G 2025

JOB NO: DRAWING TITLE: DESIGN: J3631 **CARPORT PLAN** SHEET NO: 06 DCH-8 DRAWN BY: CHECKED BY: 1:100 A3 KΑ

© 2023 REPRODUCTION IN PART OR WHOLE IS STRICTL

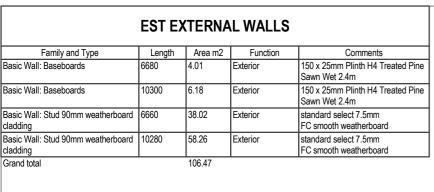



TRIMDEK® cladding has a subtle square-fluted profile, available in long lengths, so on most jobs you can have one sheet from ridge to gutter without end-laps.
TRIMDEK® cladding is made of high strength steel and despite its lightness, provides excellent spanning

and rainwater carrying capacity.

The strength, spanning ability, lightness and rigidity of TRIMDEK® cladding permits wide support spacings to be used with safety.



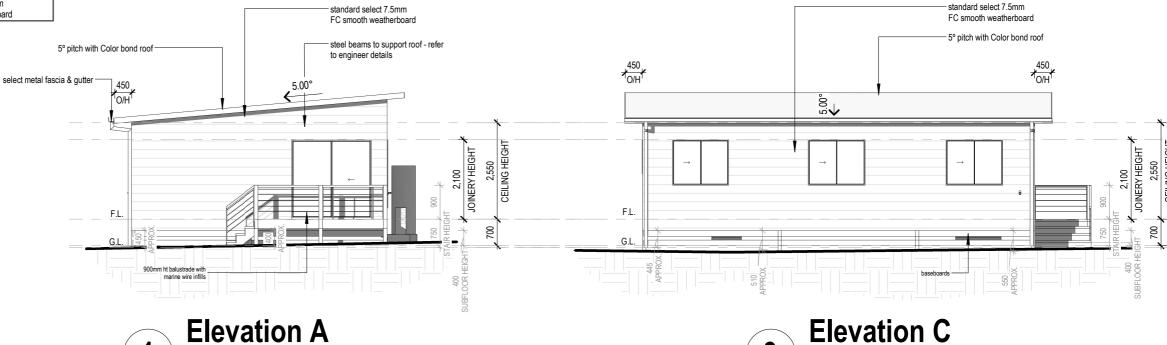

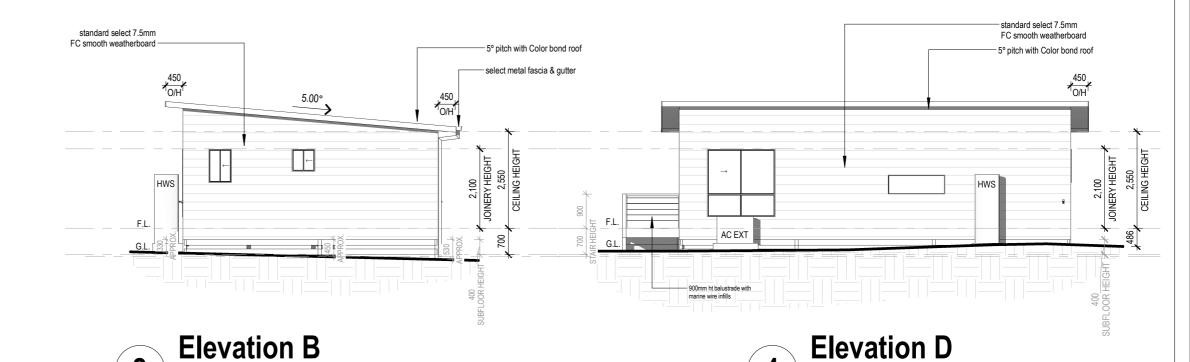

ROCKHAMPTON REGIONAL COUNCIL APPROVED PLANS

These plans are approved subject to the current conditions of approval associated with

Development Permit No.: D/49-2025

Dated: 27 August 2025

Version: 1, Version Date: 24/07/2025

PREPARED FOR EXCLUSIVE USE FOR DC HOUSE

Ph 07 5635 8990 team@dchouse.com.au

- REFRIGIRATORS, DISHWASHERS, FREEZERS AND WASHING MACHINE SYMBOLS ARE FOR POSITIONING PURPOSES ONLY WINDOWS DIMENSIONED AS HEIGHT X WIDTH

GENERAL NOTES:

1. BUILDER TO VERIFY ALL DETAILS AND DIMENSIONS PRIOR TO SITE START 2. WRITTEN DIMENSIONS TAKE PRECEDENCE OVER SCALE

1:100

 DO NOT SCALE FROM PLAN
 ALL WORK TO COMPLY WITH THE PROVISIONS OF THE BUILDING CODE OF AUSTRALIA, AUSTRALIAN STANDARDS AND ANY BYLAWS OR REQUIREMENTS OF THE LOCAL AUTHORITY 5. TERMITE PROTECTION: TREATMENT AS PER AS 3660 - 2004 & AS3600. 1/2009 (A)&(B) 6. ALL PROPOSED WORKS TO BE APPROVED BY A LICENCED CERTIFIER PRIOR TO CONSTRUCTION & ALL STRUCTURAL WORK SUBJECT TO ENGINEER DESIGN & SPECS.

	JOB DESCRIPTION: PROPOSED DUAL OCCUPANCY		CLIENT:	
	ISSUE / DATE:	REVISION:	DC HOUSE TEAM	
	CERTIFICATION	REVISION E	SITE ADDRESS:	
1	TUESDAY,22 JULY	REVISION F	259 Rockonia Rd, Koongal, QLD 470	
		REVISION G		

JOB NO: DRAWING TITLE: DESIGN: J3631 SHEET NO: **ELEVATIONS** 07 DCH-8 DRAWN BY: CHECKED BY: 1:100 KA

1:100

DC House 23-25 Prosper Crescent Burleigh Heads 4220 QBCC LIC 1310310 ACN 640 265 974 ABN 19 604 265 974

© 2023 REPRODUCTION IN PART OR WHOLE IS STRICTLY Document Set ID: 41122588