

SOIL CONSERVATION NOTE:

- PRIOR TO COMMENCEMENT OF CONSTRUCTION PROVIDE 'SEDIMENT FENCE,' 'SEDIMENT TRAP' AND WASH-OUT AREA TO ENSURE THE CAPTURE OF WATER BORNE MATERIAL GENERATED FROM THE SITE. - MAINTAIN THE ABOVE DURING THE COURSE OF CONSTRUCTION, AND CLEAR THE 'SEDIMENT TRAP AFTER

'SEDIMENT TRAP'

-500mm x 500mm WIDE 300mm DEEP PIT, LOCATED AT THE LOWEST POINT TO THE TRAP SEDIMENT.

'WASH-OUT AREA'

-TO BE 1800mm x 1800mm ALLOCATED FOR THE WASHING OF TOOL & EQUIPME



-PROVIDE 'SEDIMENT FENCE ON DOWN SLOPE BOUNDARY AS SHOWN ON PLAN. FABRIC TO BE BURIED BELOW



VEHICLE ACCESS TO SITE

-VEHICLE ACCESS TO THE BUILDING SITE SHOULD BE RESTRICTED TO A SINGLE POINT SO AS TO REDUCE THE AMOUNT OF SOIL DEPOSITED ON THE STREET

BUILDING MATERIAL STOCKPILES'

-ALL STOCKPILES OF BUILDING MATERIAL SUCH AS SAND AND SOIL MUST BE PROTECTED TO PREVENT

-THE SHOULD NEVER BE PLACED IN THE STREET GUTTER WHERE THEY WILL WASH AWAY WITH THE

'SANDBAG KERB SEDIMENT TRAP'

-IN CERTAIN CIRCUMSTANCES EXTRA SEDIMENT



NOTES:

- LOCATION OF SEWER IS TO BE IDENTIFIED PRIOR TO COMMENCEMENT OF CONSTRUCTION.
- 2. MIN 5000L RAINWATER TANK REQUIRED, POSITION SHOWN IS INDICATIVE ONLY AND MAY VARY ACCORDING TO OWNERS OR BUILDERS SPECIFICATIONS, REFER TO RAINWATER TANK INSTALLATION NOTES.
- 3. ALL GUTTER AND DOWNPIPE WORKS TO AS/NZS3500 AND BCA VOLUME 2 SECTION 3.5.2.
- 125 QUAD GUTTER MAXIMUM 40M2 OF ROOF CONTRIBUTING TO DP IN EACH DIRECTION.
- 5. ISO QUAD GUITTER MAXIMUM 60M2 OF ROOF CONTRIBUTING TO SP IN EACH DIRECTION.
- DOWNPIPES (DP) TO BE 90 DIA UPVC.
- DOWNPIPES (DP) AE TO BE MAX, I2M LINEAL APART.

STORMWATER PIPE SELECTION GLIDE

DP	SLOPE	MAX ROOF AREA CONTRIBUTION
90	1:100	80sq.m
100	1:100	100sq.m
100	1:80	130sq.m
100	1:60	160sq.m
100	1:50	180sq.m
100	1:40	200sq.m
150	1:100	3465a.m

- 9. STORMWATER MUST BE CONNECTED TO LEGAL POINT OF DISCHARGE -
 - STORMWATER KERB ADAPTERS TO STREET (2 MAX.)
 - ROOFWATER PIPE AT REAR OF BLOCK,
 - BUBBLERS TO COUNCIL SPECIFICATION.
 - RAINWATER TANK, OVERFLOW MUST CONNECT TO STORMWATER SYSTEM.
- 10. ALL CONSTRUCTION METHODS AND MATERIALS TO BE IN ACCORDANCE WITH: THE BUILDING CODE OF AUSTRALIA AND THE QUEENSLAND DEVELOPMENT CODE AND BUILDING REGULATIONS AND AUSTRALIAN STANDARDS.
- II. ANY REQUIRED EARTHWORKS INCLUDING CUT, FILL, BATTERS AND RETAINING MUST COMPLY WITH BCA 2009 VOLUME 23.1.1, AS 3798 & AS 4200.

ROCKHAMPTON REGIONAL COUNCIL

These plans are approved subject to the current conditions of approval associated with Development Permit No. D/649-2012 Dated 08-01-14

GSPC

(Gracemere Surveying and Planning Consultants Pty Ltd) ABN: 40 124 780 445 PO Box 379 Gracemere QLD 4702 Rockhampton & Toowoomba PH: (07) 4922 7033 email: admin@gspc.com.au FAX: (07) 4922 7044 Sheet No. 1/15 Scale: 1:1000

Date: 19/07/13

Client: Alfred Cecil John Judd Address: 61-65 Osborne Rd Pink Lily, Alton Downs Drawn By: Kragg Knabe

DESIGNER: Kraga Knabe Ref. No: 120465-01

3040 1100 70 70 2970 70 70 1900 1750 2970 Verandah 1815 xo/xo 1812 xo/xo 2 20 Bed 2 Bed 1 20 895 70 70 20 Lounge/Dining Kitchen Bath RF 2 20 Verandah 1900 70 7520


8990

First Floor

CARETAKER'S RESIDENCE

NOTES:

- ALL DIMENSIONS AND DETAILS TO BE CONFIRMED BEFORE COMMENCEMENT OF CONSTRUCTION AND RESPONSIBLE PEOPLE NOTIFIED OF ANY DISCREPANCIES.
- WALL FINISHES AND WINDOW TYPES ARE INDICATIVE ONLY AND ARE NOT PRESCRIPTIVE, REFER TO BUILDERS SPECIFICATIONS FOR DETAILS.
- GROUND LINE SHOWN ON ELEVATIONS DOES NOT RELATE TO ACTUAL SLOPE OF SITE.

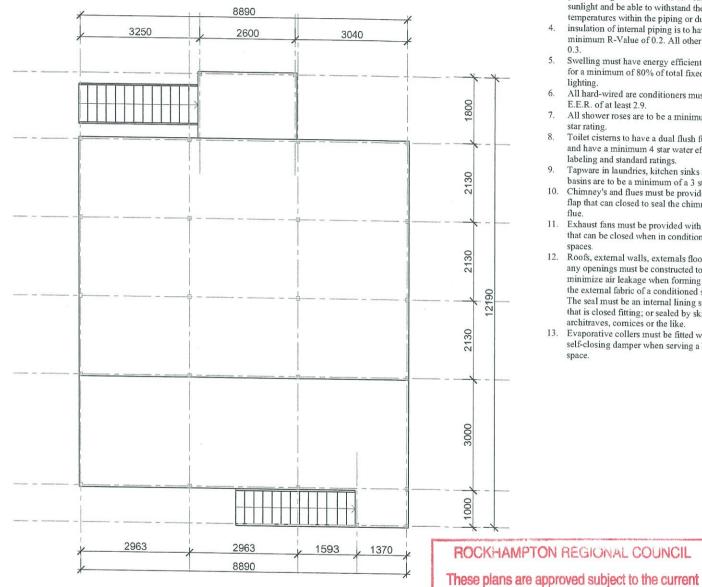

NOTES:

- 1. Class 10a buildings attached to Class 1 buildings must have an external fabric that achemes the same values of that of the class 1 building.
- 2. Hot water supply must comply with section 8 of AS/NZ 3500.4 or clause 3.38 of AS/NZS 3500.5. Solar hot water systems are not required to comply.

 3. Thermal insulation of services is to be
- protected against the effects of weather and sunlight and be able to withstand the temperatures within the piping or ductwork.
- insulation of internal piping is to have a minimum R-Value of 0.2. All other is to be
- Swelling must have energy efficient lighting for a minimum of 80% of total fixed internal
- lighting. All hard-wired are conditioners must have an E.E.R. of at least 2.9.
- 7. All shower roses are to be a minimum of a 3 star rating.
- Toilet cisterns to have a dual flush function and have a minimum 4 star water efficiency labeling and standard ratings.
- Tapware in laundries, kitchen sinks and
- basins are to be a minimum of a 3 star rating. 10. Chimney's and flues must be provided with a flap that can closed to seal the chimney or
- 11. Exhaust fans must be provided with a flap that can be closed when in conditioned spaces.
- 12. Roofs, external walls, externals floors and any openings must be constructed to minimize air leakage when forming part of the external fabric of a conditioned space. The seal must be an internal lining system that is closed fitting; or sealed by skirting, architraves, comices or the like.
- 13. Evaporative collers must be fitted with a self-closing damper when serving a heated

Post Layout

HW - 5 Star Hot Water Tank WT - 5000 Litre Water Tank

GSPC


(Gracemere Surveying and Planning Consultants Pty Ltd)
ABN: 40 124 780 445 PO Box 379 Gracemere QLD 4702 Rockhampton & Toowoomba PH: (07) 4922 7033 email: admin@gspc.com.au FAX: (07) 4922 7044 Sheet No. 2/15 Scale: 1:100

conditions of approval associated with

Development Permit No. D/649-2012

Dated 08-01-14

Date: 20/09/12 Ref. No: 120465-01

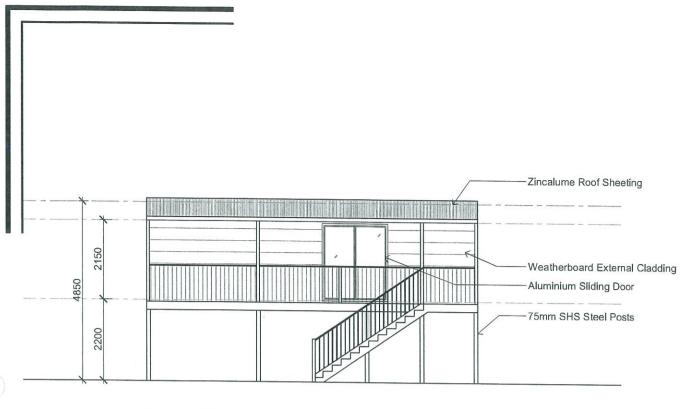


South Elevation




North Elevation

NOTES:

- I. ALL DIMENSIONS AND DETAILS TO BE CONFIRMED BEFORE COMMENCEMENT OF CONSTRUCTION AND RESPONSIBLE PEOPLE NOTIFIED OF ANY DISCREPANCIES,
- 2. WALL FINISHES AND WINDOW TYPES ARE INDICATIVE ONLY AND ARE NOT PRESCRIPTIVE, REFER TO BUILDERS SPECIFICATIONS FOR DETAILS,
- 3. GROUND LINE SHOWN ON ELEVATIONS DOES NOT RELATE TO ACTUAL SLOPE OF SITE.

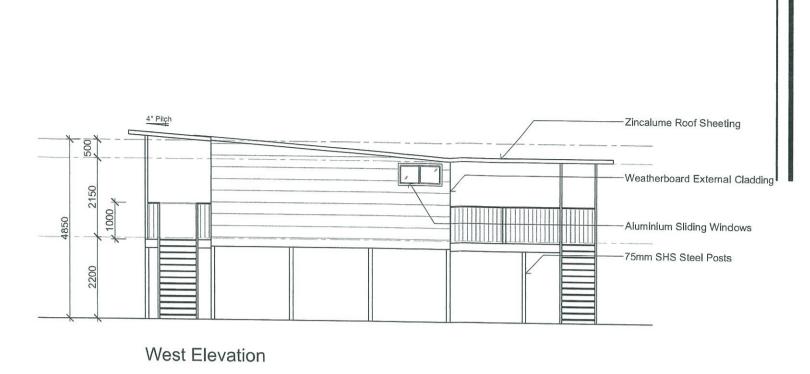

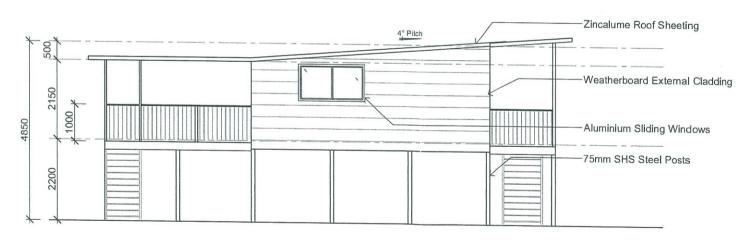

East Elevation

ROCKHAMPTON REGIONAL COUNCIL

These plans are approved subject to the current conditions of approval associated with Development Permit No. D/649-2012


Dated 08-01-14


GSPC


(Gracemere Surveying and Planning Consultants Pty Ltd)
ABN: 40 124 780 445
PO Box 379 Gracemere QLD 4702
Rockhampton & Toowoomba
PH: (07) 4922 7033 email: admin@gspc.com.au FAX; (07) 4922 7044

Sheet No. 3/15 Scale: 1:100 Date: 20/09/12

Ref. No: 120465-01

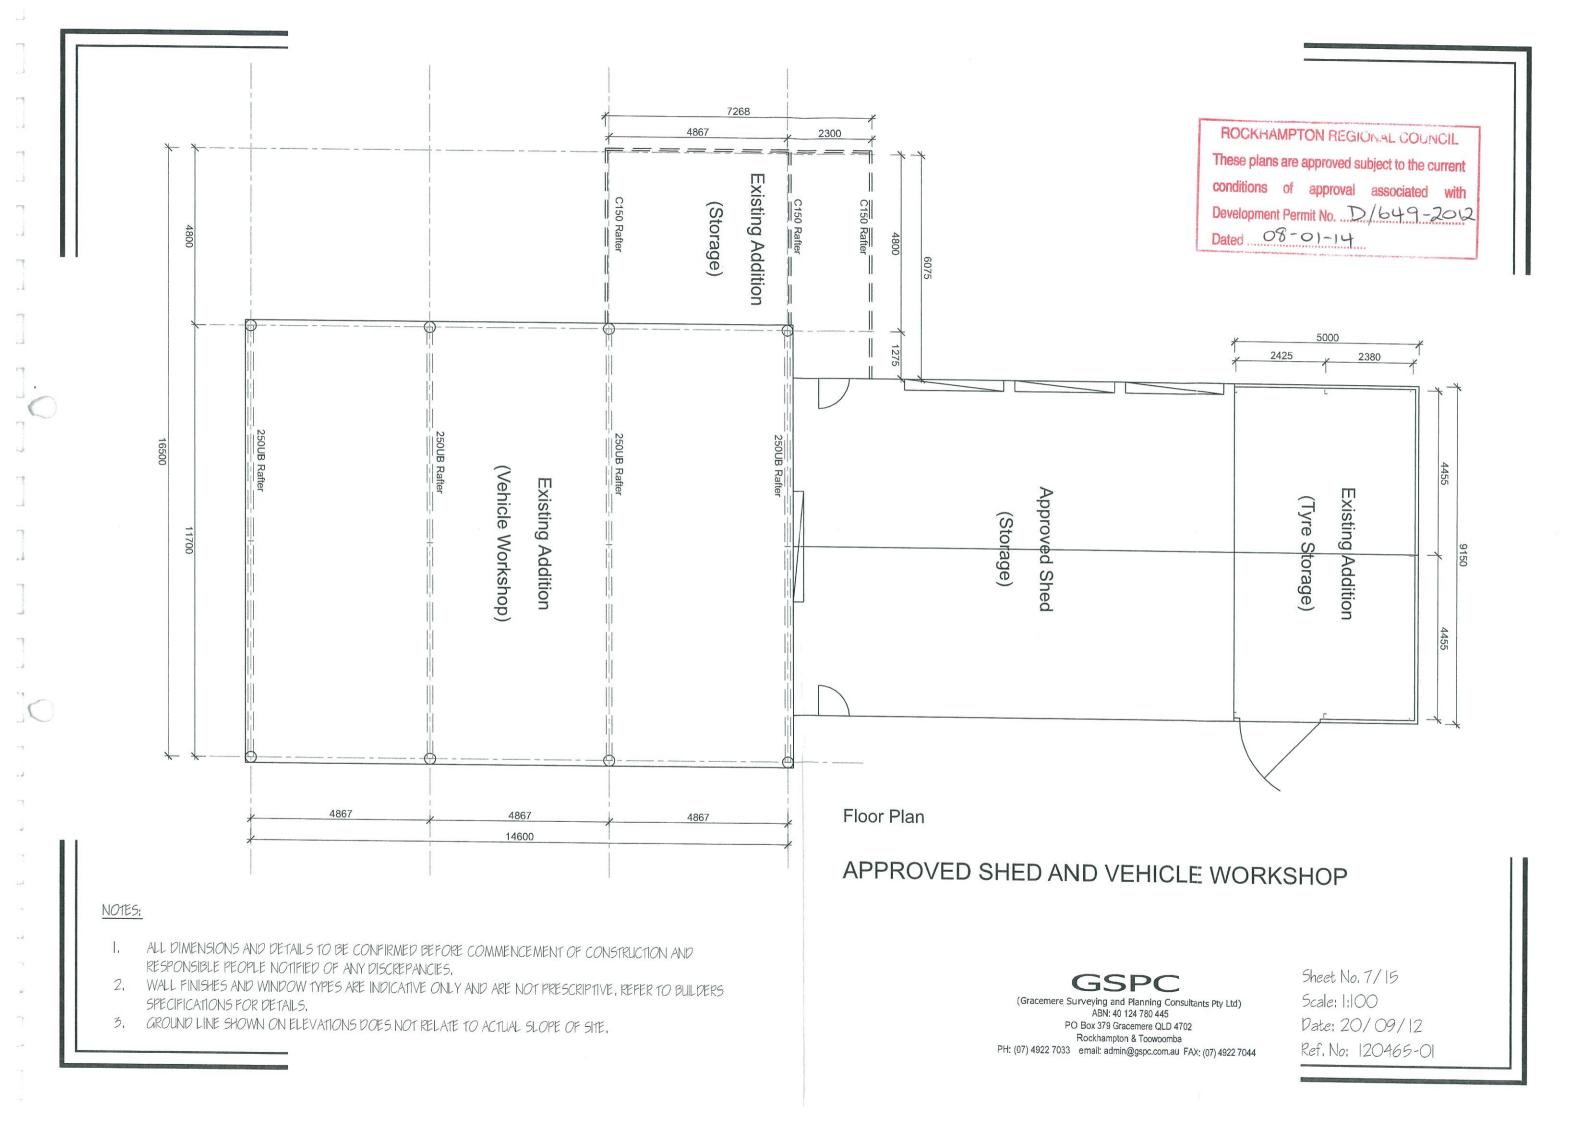

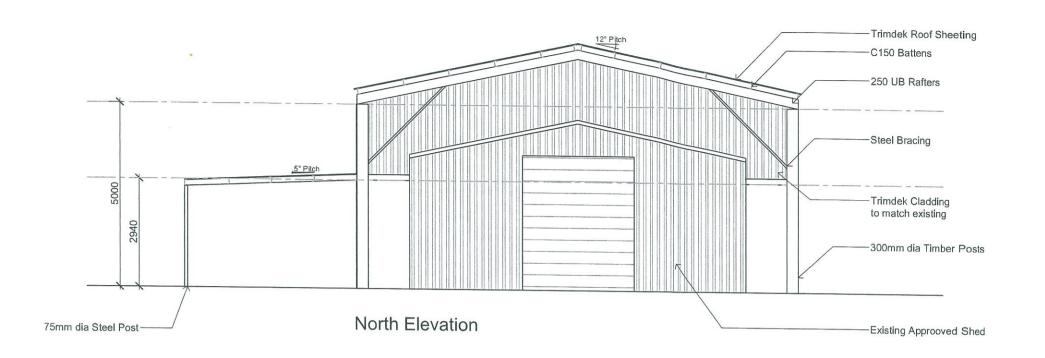

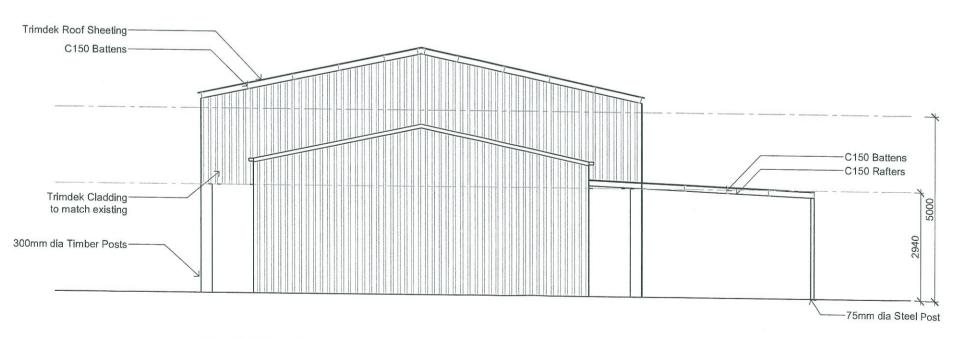

NOTES:

- building.
- Hot water supply must comply with section 8 of AS/NZ 3500.4 or clause 3.38 of AS/NZS 3500.5. Solar hot water systems are not required to comply.
- 3. Thermal insulation of services is to be protected against the effects of weather and sunlight and be able to withstand the temperatures within the piping or ductwork.
- 4. insulation of internal piping is to have a minimum R-Value of 0.2. All other is to be
- Swelling must have energy efficient lighting for a minimum of 80% of total fixed internal
- All hard-wired are conditioners must have an E.E.R. of at least 2.9.
- 7. All shower roses are to be a minimum of a 3 star rating.
- 8. Toilet cisterns to have a dual flush function and have a minimum 4 star water efficiency labeling and standard ratings.
- Tapware in laundries, kitchen sinks and
- basins are to be a minimum of a 3 star rating.

 Chimney's and flues must be provided with a flap that can closed to seal the chimney or
- 11. Exhaust fans must be provided with a flap that can be closed when in conditioned
- spaces.
 12. Roofs, external walls, externals floors and any openings must be constructed to minimize air leakage when forming part of the external fabric of a conditioned space. The seal must be an internal lining system that is closed fitting; or sealed by skirting, architraves, cornices or the like.
- 13. Evaporative collers must be fitted with a self-closing damper when serving a heated

ROCKHAMPTON REGIONAL COUNCIL

These plans are approved subject to the current conditions of approval associated with Development Permit No. D/649-2012 Dated 08-01-14

NOTES:

South Elevation


- ALL DIMENSIONS AND DETAILS TO BE CONFIRMED BEFORE COMMENCEMENT OF CONSTRUCTION AND RESPONSIBLE PEOPLE NOTIFIED OF ANY DISCREPANCIES.
- 2. WALL FINISHES AND WINDOW TYPES ARE INDICATIVE ONLY AND ARE NOT PRESCRIPTIVE, REFER TO BUILDERS SPECIFICATIONS FOR DETAILS.
- 3. GROUND LINE SHOWN ON ELEVATIONS DOES NOT RELATE TO ACTUAL SLOPE OF SITE.


GSPC

(Gracemere Surveying and Planning Consultants Pty Ltd) ABN: 40 124 780 445 PO Box 379 Gracemere QLD 4702 Rockhampton & Toowoomba PH: (07) 4922 7033 email: admin@gspc.com.au FAX: (07) 4922 7044 Sheet No. 8/15 Scale: 1:20

Date: 20/09/12

Ref. No: 120465-01

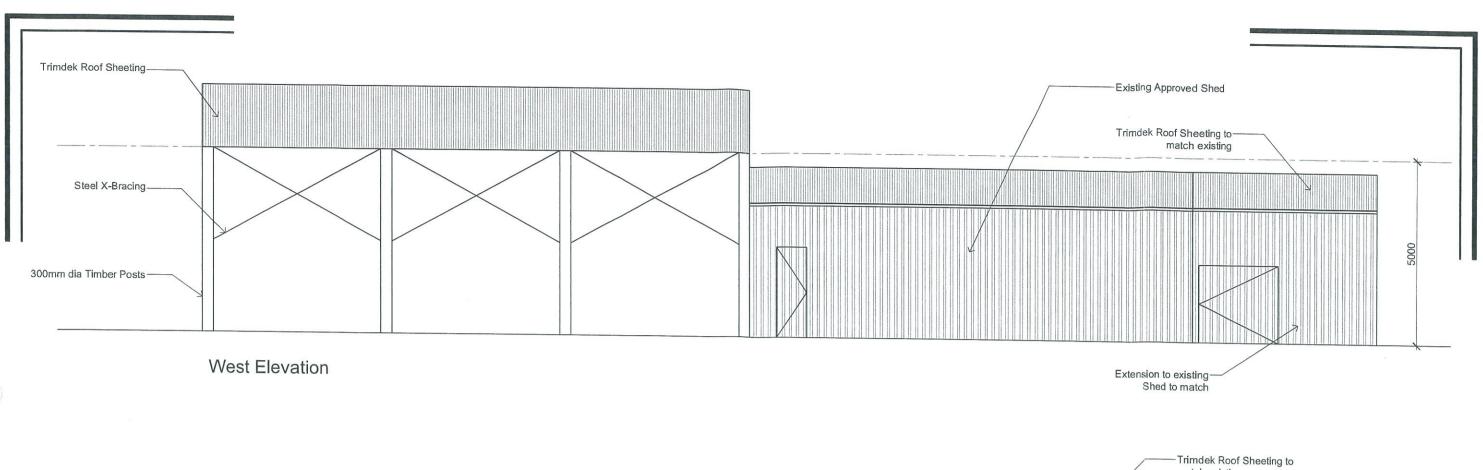

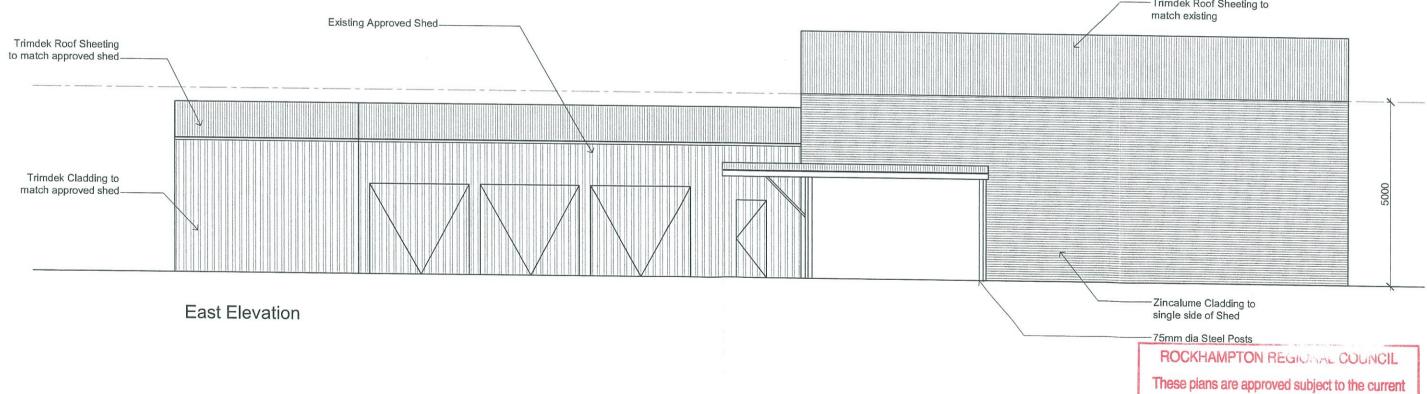

NOTES:

- I. ALL DIMENSIONS AND DETAILS TO BE CONFIRMED BEFORE COMMENCEMENT OF CONSTRUCTION AND RESPONSIBLE PEOPLE NOTIFIED OF ANY DISCREPANCIES.
- 2. WALL FINISHES AND WINDOW TYPES ARE INDICATIVE ONLY AND ARE NOT PRESCRIPTIVE, REFER TO BUILDERS SPECIFICATIONS FOR DETAILS.
- 3. GROUND LINE SHOWN ON ELEVATIONS DOES NOT RELATE TO ACTUAL SLOPE OF SITE.

GSPC

(Gracemere Surveying and Planning Consultants Pty Ltd)
ABN: 40 124 780 445
PO Box 379 Gracemere QLD 4702
Rockhampton & Toowoomba

Rockhampton & Toowoomba
PH: (07) 4922 7033 email: admin@gspc.com.au FAX: (07) 4922 7044

Sheet No. 9/15

conditions of approval associated with Development Permit No. D/649-2012

Scale: 1:100

Dated 08-01-14

Date: 20/09/12

Ref. No: 120465-01