GENERAL NOTES

- G1. THESE DRAWINGS SHALL BE READ IN CONJUNCTION WITH ALL SUCH OTHER WRITTEN INSTRUCTION OR SKETCHES AS MAY BE ISSUED DURING THE COURSE OF THE CONTRACT.
- G2. ALL DISCREPANCIES SHALL BE REFERRED TO THE PROJECT SUPERINTENDENT FOR RESOLUTION BEFORE PROCEEDING WITH THE WORK.
- G3. ALL MATERIALS AND WORKMANSHIP SHALL BE IN ACCORDANCE WITH THE RELEVANT CURRENT SAA CODES AND THE BY-LAWS, ORDINANCES AND REQUIREMENTS OF RELEVANT BUILDING AND STATUTORY AUTHORITIES EXCEPT WHERE VARIED BY THE PROJECT SPECIFICATION.
- G4. ALL DIMENSIONS SHALL BE VERIFIED BY THE CONTRACTOR PRIOR TO CONSTRUCTION AND FABRICATION.
- G5. ALL DIMENSIONS ARE IN MILLIMETRES AND ALL LEVELS ARE IN METRES UNLESS NOTED OTHERWISE.
- G6. NOMINATION OF PROPRIETARY ITEMS DOES NOT INDICATE EXCLUSIVE PREFERENCE, BUT INDICATES THE MINIMUM REQUIRED PROPERTIES OF THE ITEM. SIMILAR ALTERNATIVES HAVING AT LEAST THE MINIMUM REQUIRED PROPERTIES MAY BE OFFERED FOR APPROVAL. INSTALL PROPRIETARY ITEMS STRICTLY IN ACCORDANCE WITH THE MANUFACTURER'S SPECIFICATIONS.
- G7. TAKE ALL REASONABLE PRECAUTIONS TO ESTABLISH THE LOCATION OF, AND PROTECT, EXISTING SERVICES AT THE SITE. SERVICES SHOWN ON THE DRAWINGS ARE IN APPROXIMATE LOCATIONS ONLY. SERVICES OTHER THAN THOSE SHOWN MAY EXIST ON THE SITE.
- G8. THE ENGINEERING DRAWINGS MUST NOT BE SCALED FOR DIMENSIONS.
- G9. DURING CONSTRUCTION THE STRUCTURE SHALL BE MAINTAINED IN A STABLE CONDITION AND NO PART SHALL BE OVERSTRESSED BY CONSTRUCTION ACTIVITY. TEMPORARY SUPPORT SHALL BE PROVIDED AS REQUIRED TO KEEP ALL CONSTRUCTION WORKS STABLE.

DESIGN CRITERIA

D1. THE STRUCTURAL COMPONENTS DETAILED ON THESE DRAWINGS HAVE BEEN DESIGNED FOR LOADINGS GENERALLY IN ACCORDANCE WITH AS 1170.1:2002, IN PARTICULAR THE FOLLOWING:

LIVE LOADS

AREA	LOAD					
ROOF	1.1 kN <u>OR</u> 0.25 kPa					
FLOOR GENERALLY	4.5 kN <u>OR</u> 5.0 kPa					

WIND LOADS

PRESSURE COEFFICIENTS

REGION	C
IMPORTANCE LEVEL	2
REFERENCE PROBABILITY OF EXCEEDANCE	R _{ULTIMATE} = 500 R _{SERVICABILITY} = 25
TERRAIN CATEGORY	2.5
ULTIMATE DESIGN SITE WIND SPEED	61 m/s
SERVICABILITY DESIGN SITE WIND SPEED	41 m/s

 $C_{P,I} = -0.58$

 $C_{PW} = -0.48$

ROCKHAMPTON REGIONAL COUNCIL APPROVED PLANS

These plans are approved subject to the current conditions of approval associated with

Development Permit No: D/5-2018

Dated: 15 February 2018

STEELWORK

- S1. STRUCTURAL STEELWORK SHALL BE IN ACCORDANCE WITH THE REQUIREMENTS OF AS 4100 AND AS/NZS 5131.
- S2. ALL STRUCTURAL STEEL SHALL CONFORM TO THE FOLLOWING TABLE U.N.O.

COMPONENT	AUSTRALIAN STANDARDS	GRADE		
HOT ROLLED SECTION	AS/NZS 3679.1; TS 102	300		
WELDED BEAMS AND COLUMNS	AS/NZS 3679.2; TS 102	300		
PLATE	AS/NZS 3678; TS 102	250		
FLAT	AS/NZS 1594; TS 102	300		
QUENCH AND TEMPERED PLATE	AS 3597	690		
HOLLOW SECTIONS: CIRCULAR (CHS) SQUARE (SHS) RECTANGULAR (RHS)	AS/NZS 1163; TS102	C350L0 C350L0 C350L0		

- S3. ALL STRUCTURAL STEEL SHALL BE SOURCED FROM MILLS WITH A RELEVANT JAS ANZ ACCREDITED THIRD-PARTY CERTIFICATION SCHEME (e.g. ACRS SCHEME). ALTERNATIVE SOURCING OF THIRD-PARTY CERTIFIED STRUCTURAL STEEL SHALL BE SUBMITTED FOR REVIEW AND MUST BE APPROVED PRIOR TO COMMENCEMENT OF PROCUREMENT.
- S4. IN ACCORDANCE WITH AS/NZS 5131, THE CONSTRUCTION CATEGORIES ARE:

	ELEMENT	IMPORTANCE LEVEL	SERVICE CATEGORY	FABRICATION CATEGORY	CONSTRUCTION CATEGORY
1	ALL STRUCTRAL STEELWORK	IL2	SC1	FC1	CC2

- S5. THE PROPRIETOR SHALL BE RESPONSIBLE FOR SHOP DRAWINGS THAT SHALL COMPLY WITH THESE DRAWINGS.
- S6. UNLESS OTHERWISE SHOWN ON THE DRAWINGS:
 - (I) STANDARD CONNECTION DETAILS SHALL CONFORM TO AUSTRALIAN STEEL INSTITUTE'S STANDARDISED STRUCTURAL CONNECTIONS.
 - (II) ENSURE MEMBERS ARE CONCENTRIC AT CONNECTIONS.
 - (III) PROVIDE STEEL MEMBERS MADE FROM WHOLE LENGTHS WHEREVER POSSIBLE. IF NECESSARY, MAKE LENGTHS UP OF SECTIONS JOINED BY COMPLETE PENETRATION FULL STRENGTH BUTT WELDS GROUND FLUSH. WHERE THIS IS PROPOSED, SHOW THE JOINTS ON THE SHOP DRAWINGS.
- (IV)PROVIDE BEAM CHAMBER AS NOTED. (V) SHOP DRAWINGS SHALL BE SUBMITTED TO THE PRINCIPAL FOR APPROVAL PRIOR TO THE
- COMMENCEMENT OF FABRICATION. S7. ALL STRUCTURAL STEELWORK SHALL BE FABRICATED BY COMPETENT PERSONNEL IN ACCORDANCE
- WITH AS/NZS 5131. S8. FABRICATION TOLERANCES SHALL CONFORM TO THE REQUIREMENTS OF AS/NZS 5131. THE TOLERANCE CLASS FOR FUNCTIONAL TOLERANCE SHALL BE CLASS 1 U.N.O.
- S9. ALL CUTTING, HOLING AND SHAPING OF STRUCTURAL STEEL SHALL CONFORM TO THE REQUIREMENTS OF AS/NZS 5131. PENETRATIONS OR CUT-OUTS OTHER THAN THOSE SHOWN ON THE DRAWINGS SHALL NO BE MADE WITHOUT PRIOR APPROVAL.

STRUCTURAL STEEL PROTECTIVE COATINGS

SP1. UNLESS NOTED OTHERISE, FOR THE ELEMENTS ON THIS PROJECT, THE TREATMENT GRADES ACCORDING TO AS/NZS 5131 SHALL BE:

	ELEMENT	TREATMENT GRADE		
1	ALL PAINTED STRUCTRAL STEELWORK U.N.O.	P2		

SP2 THE COATING QUALITY LEVEL ASSESSED IN ACCORDANCE WITH AS /NZS 5131 SHALL BE-

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		ELEMENT	COATING QUALITY
	1	ALL PAINTED STRUCTRAL STEELWORK U.N.O.	PC2

SP3. STEELWORK TO BE HOT DIPPED GALVANISED IN ACCORDANCE WITH AS 4680, SHALL CONFORM TO THE REQUIREMENTS OF AS/NZS 5131.

STRUCTURAL STEEL WELDING

SW1.(A) WELDING SHALL BE PERFORMED BY AN EXPERIENCED OPERATOR IN ACCORDANCE WITH AS 1554 -CATEGORY SP.

(D) BUTT WELDS SHALL BE PRE-QUALIFIED FULL PENETRATION UNLESS NOTED OTHERWISE.

- (B) MANUAL METAL ARC ELECTRODES SHALL BE E48XX IN ACCORDANCE WITH AS 1553.1. OTHER WELDING METHODS SHALL USE EQUIVALENT NOMINAL TENSILE STRENGTH WELD METALS.
- (C) WELDING SYMBOLS ARE IN ACCORDANCE WITH AS 1101 PART 3

(E) ALL SHOP FABRICATED JOINTS FOR STRUCTURAL STEEL SHALL BE FULLY WELDED USING 6 mm CONTINUOUS FILLET WELDS UNLESS NOTED OTHERWISE.

10%

(F) CLEATS TO BE 10 mm PLATE UNLESS NOTED OTHERWISE.

MAGNETIC PARTICLE EXAMINATION - FILLET WELDS

- (G) ALL PLATES, GUSSETS, ETC. SHALL HAVE SHARP EDGES AND CORNERS GROUND SMOOTH.
- SW2.WELD TESTING SHALL BE IN ACCORDANCE WITH AS 1554.1 SECTION 7 AS FOLLOWS:
 - (I) VISUAL SCANNING
 - (II) VISUAL EXAMINATION 50% (III) DYE PENETRANT OR BUTT WELDS

STRUCTURAL STEEL BOLTING

SB1. BOLT DESIGNATION

DESIGNATION	DESCRIPTION
4.6/S 4.6N/S 4.6X/S	COMMERCIAL GRADE 4.6 BOLTS TO AS 1111, TIGHTEND TO A SNUG TIGHT CONDITION TO AS/NZS 5131. 4.6N/S BOLTS MAY HAVE THREADS INCLUDED IN THE JOINT SHEAR PLANE. 4.6X/S BOLTS SHALL HAVE THREADS EXCLUDED FROM THE JOINT SHEAR PLANE.
8.8/S 8.8N/S 8.8X/S	HIGH STRENGTH, STRUCTURAL, GRADE 8.8 BOLTS TO AS 1252.1, TIGHTEND TO A SNUG TIGHT CONDITION TO AS/NZS 5131. 8.8N/S BOLTS MAY HAVE THREADS INCLUDED IN THE JOINT SHEAR PLANE. 8.8X/S BOLTS SHALL HAVE THREADS EXCLUDED FROM THE JOINT SHEAR PLANE.
8.8/TB 8.8N/TB 8.8X/TB	HIGH STRENGTH, STRUCTURAL, GRADE 8.8 BOLTS TO AS 1252.1, FULLY TENSIONED TO AS/NZS 5131 AS A BEARING JOINT. 8.8N/TB BOLTS MAY HAVE THREADS INCLUDED IN THE JOINT SHEAR PLANE. 8.8X/TB BOLTS SHALL HAVE THREADS EXCLUDED FROM THE JOINT SHEAR PLANE.
8.8/TF 8.8N/TF 8.8X/TF	HIGH STRENGTH, STRUCTURAL, GRADE 8.8 BOLTS TO AS 1252.1, FULLY TENSIONED TO AS/NZS 5131 AS A FRICTION JOINT. 8.8N/TF BOLTS MAY HAVE THREADS INCLUDED IN THE JOINT SHEAR PLANE. 8.8X/TF BOLTS SHALL HAVE THREADS EXCLUDED FROM THE JOINT SHEAR PLANE.

- SB2.(A) UNLESS NOTED OTHERWISE PROVIDE M20 HIGH STRENGTH BOLTS, NUTS AND WASHERS, HOT DIPPED GALVANISED TO AS/NZS 1214.
 - (B) ALL HIGH STRENGTH STRUCTURAL BOLTS SHALL BE VERIFIED TO AS 1252.2. A SUPPLIER DECLARATION OF CONFORMITY IN ACCORDANCE WITH AS 1252.2 SHALL BE PROVIDED.
 - (C) ALL BOLTS TO BE SNUG TIGHTENED IN ACCORDANCE WITH AS/NZS 5131 UNLESS NOTED OTHERWISE.
 - (D) ALL BOLTS SHALL BE OF SUCH LENGTH THAT AT LEAST TWO FULL THREAD IS EXPOSED BEYOND THE NUT AFTER THE NUT HAS BEEN TIGHTENED.
 - (E) USE BOLTS WITH THREADS IN COMPLIANCE WITH AS 1275 AND WASHERS IN COMPLIANCE WITH AS 1237 U.N.O.
 - (F) MINIMUM ONE WASHER SHALL BE USED UNDER THE NUT IN ALL SITUATIONS. IF TIGHTENING IS CARRIED OUT AT THE HEAD, AN ADDITIONAL WASHER SHALL BE USED UNDER THE HEAD. FOR SLOTTED HOLES USE HARDENED WASHERS UNDER THE NUT AND BOLT HEAD.
 - (G) ALL EXPOSED NUTS, BOLTS AND WASHERS (INCLUDING H.D. BOLTS) TO BE HOT DIPPED GALVANISED TO AS 1214 UNLESS NOTED OTHERWISE.
 - (H) HOLDING DOWN BOLTS TO BE SUPPLIED COMPLETE WITH LEVELLING NUTS, NUTS AND EXTRA LARGE FLAT WASHERS.
 - (I) TIE HOLDING DOWN BOLT GROUPS RIGIDLY TOGETHER PRIOR TO INSTALLATION. PROVIDE A MINIMUM 3 mm THICK MILD STEEL PLATE TEMPLATE. BOLT GROUPS USING GRADE 4.6 BOLTS CAN BE TACK WELDED TOGETHER USING R10 BAR TO FORM A CAGE. DO NOT WELD GRADE 8.8 BOLTS UNLESS NOTED OTHERWISE ON THE DRAWINGS.
 - (J) ALL M12 BOLTS AND CAST-IN HOLD DOWN BOLTS ARE IN 4.6/S PROCEDURE UNLESS NOTED OTHERWISE.
- SB3. WHERE /TB AND /TF TENSION METHODS HAVE BEEN SPECIFIED, BOLTS SHALL BE INSTALLED USING EITHER THE PART TURN METHOD OR THE DIRECT TENSION INDICATOR METHOD IN ACCORDANCE WITH AS/NZS 5131.
- SB4. WHERE /TF TENSION METHODS HAVE BEEN SPECIFIED, A FRICTION COEFFICIENT OF 0.35 HAS BEEN ADOPTED FOR THE DESIGN. THE CONTACT SURFACES SHALL BE PREPARED IN ACCORDANCE WITH AS/MZS 5131 AND BE FREE FROM PAINT, LACQUER OR OTHER APPLIED FINISHES UNLESS THE APPLIED FINISH HAS BEEN TESTED IN ACCORDANCE WITH AS/NZS 5131 APPENDIX G AND A FRICTION COEFFICIENT OF 0.35 OR HIGHER IS DETERMINED.

STRUCTURAL STEEL ERECTION

- SE1. STRUCTURAL STEELWWORK ERECTION SHALL CONFORM TO AS/NZS 5131.
- SE2. ALL MEMBERS HAVING A NATURAL CAMBER WITHIN THE STRAIGHTNESS TOLERANCE SHALL BE ERECTED WITH THE NATURAL CAMBER UP.
- SE3. (A) ERECTION TOLERANCES SHALL COMPLY TO THE REQUIREMENTS OF AS/NZS 5131.
- (B) THE TOLERANCE CLASS FOR FUNCTIONAL TOLERANCES SHALL BE CLASS 1 UNLESS NOTED OTHERWISE.
- SE4. SUBMIT THE ERECTION SEQUENCE METHODOLOGY.

ISSUED FOR CONSTRUCTION

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- T1. UNLESS NOTED OTHERWISE, ALL STRUCTURAL TIMBER FRAMING AND CONNECTIONS SHALL COMPLY
 - AS 1720.1-2010 TIMBER STRUCTURES PART 1: DESIGN METHODS
- AS 1684.3-2010 RESIDENTIAL TIMBER-FRAMED CONSTRUCTION PART 3: CYCLONIC AREAS T2. PROVIDE TIMBER WITH DURABILITY CLASS AND/OR PRESERVATIVE TREATMENT SUITED TO THE INTENDED APPLICATION AS RECOMMENDED BY AS 1684.
- T3. UNLESS NOTED OTHERWISE, STRUCTURAL TIMBER SHALL HAVE THE FOLLOWING PROPERTIES:

DESCRIPTION	GRADE	STRENGTH GROUP	JOINT GROUP
HARDWOOD - SEASONED	F17	SD3	JD2
HARDWOOD - UNSEASONED	F14	S3	J2
SOFTWOOD - SEASONED	MGP10 MGP12	SD6	JD4*

- * HEART-IN MATERIAL IS TO BE EXCLUDED FOR MGP 10 JD4 CLASSIFICATION
- T4. ALL BOLTS/THREADED RODS IN TIMBER FRAMING SHALL HAVE WASHERS UNDER BOLT HEAD AND NUT RESPECTIVELY WHERE THE BOLT HEAD/NUT BEARS ON THE TIMBER. WASHER SIZES SHALL

BOLT SIZE	WASHER THICKNESS (mm)	WASHER DIAMETER (mm)	WASHER SIDE, IF SQUARE (mm)
M10	2.5	45	40
M12	3.0	55	50
M16	4.0	65	57
M20	5.0	75	65

- T5. ALL BOLTS. THREADED RODS, NUTS, AND WASHERS SHALL BE EITHER HOT DIPPED GALVANISED OR STAINLESS STEEL.
- T6. IN COASTAL AREAS SUBJECT TO CORROSION FROM SALT LADEN AIR, ALL EXPOSED STRUCTURAL FASTENERS (BOLTS, SCREWS, NAILS AND THE LIKE) SHALL BE SUITABLE STAINLESS STEEL FASTENERS.

FOUNDATION SYSTEMS

- F1. FOUNDATION SYSTEMS HAVE GENERALLY BEEN DESIGNED IN ACCORDANCE WITH AS 2870-2011, ACCEPTED ENGINEERING PRACTICE AND PRINCIPLES.
- F2. IN DESIGNING THE FOUNDATION SYSTEM, WE HAVE RELIED UPON BUTLER PARTNERS' REPORT, THEIR PROJECT No. R17-204A, TITLED "GEOTECHNICAL INVESTIGATION PROPOSED SHADE STRUCTURE AND ABLUTION BLOCK TOONOOBA PARK, 287-289 QUAY STREET, ROCKHAMPTON", DATED 20/11/2017, WHICH NOMINATES:
 - (I) SITE CLASS 'P' WITH UPTO 1400 DEEP UNCONTROLLED FILL.
 - (II) BORED CAST INSITU PILES DESIGNED BASED ON MAXIMUM ALLOWABLE WORKING BEARING PRESSURE.
 - AT SHAFT = 15 KPa
 - AT BASE = 150 KPa

ADDITIONAL INFORMATION WE HAVE RELIED UPON INCLUDES REAL PROPERTY DESCRIPTION, EXISTING LEVELS. STRUCTURES, DRAINAGE AND TREES, AND PROPOSED BUILDING AND EARTH WORKS.

F3. FOR FOUNDATION SYSTEMS FOUNDED ON REACTIVE CLAY SITES:

UNLESS ACKNOWLEDGED IN WRITING. NO ALLOWANCE FOR ABNORMAL MOISTURE CONDITIONS (REFER AS 2870-2011 CLAUSE 1.3.3) HAS BEEN MADE. SHOULD SUCH CONDITIONS EXIST. THE ENGINEER IS TO BE NOTIFIED AND THEIR OPINION SOUGHT.

- (I) IT IS THE RESPONSIBILITY OF THE BUILDER TO COMPLY WITH THE REQUIREMENTS OF CLAUSE 5.6 OF AS 2870-2011.
- (II) THE FOUNDATION SYSTEM/S HAS GENERALLY BEEN DESIGNED FOR ARTICULATED CLADDING IN ACCORDANCE WITH AS 2870-2011. ARTICULATION OF OTHER EXTERNAL, AND INTERNAL LININGS SHOULD COMPLIMENT THE ARTICULATION OF EXTERNAL WALLS.
- (III) THE OWNER IS TO MAINTAIN THE LANDSCAPE WITHIN AND SURROUNDING THE FOUNDATION SYSTEM SO AS TO MAINTAIN A RELATIVELY CONSISTENT LONG TERM MOISTURE REGIME WITHIN THE SOIL. GUIDES AS TO HOW TO ACHIEVE THIS MAY BE FOUND IN THE FOLLOWING LITERATURE:
 - AS 2870-2011 RESIDENTIAL SLABS AND FOOTINGS, SECTION 5 AND 6;
 - CSIRO BUILDING TECHNOLOGY FILE BTF18-2003 "FOUNDATION AND FOOTING PERFORMANCE: A HOMEOWNERS GUIDE", AVAILABLE FROM www.csiro.com.au.
 - QUEENSLAND BUILDING AND CONSTRUCTION COMMISSION "A SIMPLE HOW TO GUIDE TO PREVENTING STRUCTURAL DAMAGE TO YOUR HOME" AVAILABLE FROM www.gbcc.gld.gov.qu.

CONCRETE

5

IN ACCORDANCE WITH AS 3600

- C1. ALL STRUCTURAL CONCRETE SHALL BE IN ACCORDANCE WITH AS 3600. WORKMANSHIP AND
- MATERIALS SHALL BE IN ACCORDANCE WITH AS 3600, AS 3610 AND AS 1379. C2. COVER TO REINFORCEMENT AND CONCRETE GRADES SHALL BE AS FOLLOWS UNLESS NOTED OTHERWISE: -

		COVER	ODADE		
ELEMENT	EXPOSURE	SURFACES CAST AGAINST GROUND	FORMED OR FINISHED	GRADE (MIN.)	
FOOTINGS	NON-AGRESSIVE	50	50	N25	
SLABS	EXTERIOR	50	30	N32	

- COVER IS THE CLEAR DISTANCE BETWEEN ANY REINFORCING (INCLUDING FITMENTS) AND THE FACE OF THE STRUCTURAL ELEMENT.
- FOR ALL EXTERNAL SURFACES, PROVIDE FULLY PLASTIC BAR CHAIRS. TIE WIRE SHALL NOT BE NAILED TO THE FORMS.
- PROVIDE AN APPROVED 0.20 mm DAMP PROOF MEMBRANE UNDER ALL CONCRETE SURFACES ON GROUND.
- THE REINFORCEMENT COVERS SHALL BE MAINTAINED USING APPROVED BAR CHAIRS. IN SLABS THE BAR CHAIRS SHALL BE AT 800 mm x 800 mm MAXIMUM CENTRES.
- C3. ALL CONCRETE SUPPLIED SHALL BE NORMAL CLASS CONCRETE IN ACCORDANCE WITH AS 3600 AND HAVE A SLUMP OF 80 mm AND A MAXIMUM NOMINAL AGGREGATE SIZE OF 20 mm UNLESS NOTED OTHERWISE. THE ENGINEER SHALL APPROVE VARIATIONS FROM THESE.
- C4. USE READY MIX CONCRETE MIXED BY THE BATCH PRODUCTION PROCESS DELIVERED IN AGITATING TRUCKS. OBTAIN APPROVAL BEFORE ADDING WATER AT THE SITE. FOR EACH BATCH OF CONCRETE, SUPPLY A DOCKET LISTING THE INFORMATION REQUIRED BY AS 1379 CLAUSE 1.7.3 AND THE FOLLOWING:
 - THE ELEMENT FOR WHICH THE CONCRETE WAS ORDERED;
 - THE TOTAL AMOUNT OF WATER ADDED AT THE PLANT AND THE MAXIMUM AMOUNT
- PERMITTED TO BE ADDED AT SITE; AND
- (III) THE AMOUNT OF WATER, IF ANY, ADDED AT THE SITE. C5. THE MANUFACTURER IS TO CARRY OUT PRODUCTION ASSESSMENT OF CONCRETE FOR COMPLIANCE WITH THE REQUIREMENTS OF AS 3600 SECTION 17.1, AND AS 1379. FORWARD PRODUCTION ASSESSMENT REPORTS TO THE SUPERINTENDENT AS PER AS 1379 APPENDIX
- C6. USE CONCRETE PLACING METHODS TO MINIMISE PLASTIC SETTLEMENT AND SHRINKAGE CRACKING. LIMIT VERTICAL FREE FALL OF CONCRETE TO LESS THAN 1500 mm. PROPERLY COMPACT CONCRETE USING MECHANICAL VIBRATION TO GIVE MAXIMUM COMPACTION WITHOUT SEGREGATION.
- C7. KEEP ON SITE A LOG BOOK RECORDING EACH CONCRETE PLACEMENT INCLUDING DATE, BATCH DOCKET NUMBER, PORTION OF THE WORK, AND VOLUME PLACED.
- C8. PROVIDE PROPOSED LOCATION AND DETAILS OF CONSTRUCTION JOINTS FOR THE SUPERINTENDENT'S APPROVAL PRIOR TO CONSTRUCTION. CONSTRUCTION JOINTS IN SLABS SHALL BE VERTICAL AND IN WALLS SHALL BE HORIZONTAL. ENSURE CONSTRUCTION JOINT SURFACES ARE CLEAN AND FREE OF LAITANCE. LOOSE MATERIAL AND FOREIGN MATTER. AND DELIBERATELY ROUGHENED IN ACCORDANCE WITH TABLE 8.4.4 OF AS 3600. PRIOR TO PLACING ADJACENT FRESH CONCRETE, PRIME EXISTING CONCRETE SURFACE WITH BASF "CONCRESIVE 2525" OR APPROVED EQUIVALENT IN ACCORDANCE WITH MANUFACTURER'S
- SPECIFICATIONS. C9. ALL TRAFFICABLE SLABS SHALL BE FINISHED WITH A NON-SLIP SURFACE. ALL OTHER EXPOSED SURFACES SHALL BE FINISHED TO A CLASS 4 SURFACE FINISH IN ACCORDANCE WITH AS 3610.
- C10. ALL FORMED EXPOSED EDGES AND RE-ENTRANT CORNERS SHALL BE CHAMFERED OF FILLETED 20 mm.
- C11. DO NOT MAKE HOLES, CHASES NOR EMBED PIPES, OTHER THAN THOSE SHOWN ON THE STRUCTURAL DRAWINGS, WITHOUT THE APPROVAL OF THE SUPERINTENDENT.
- C12. COMMENCE CURING OF CONCRETE IN ACCORDANCE WITH AS 3600 AS SOON AS PRACTICABLE AFTER PLACING OR STRIPPING. ACCEPTABLE METHODS OF CURING INCLUDE: -MOIST CURING BY PONDING OR CONTINUOUS SPRINKLING OF WATER:
 - AN IMPERMEABLE MEMBRANE:
 - (III) AN ABSORPTIVE COVER KEPT CONTINUOUSLY WET;
 - (IV) STEAM CURING: AND
 - (V) AN APPROVED CURING COMPOUND.
 - IF IT IS PROPOSED TO USE A LIQUID MEMBRANE FORMING CURING COMPOUND SUBMIT THE FOLLOWING INFORMATION:
 - CERTIFIED TEST RESULTS FOR WATER RETENTION TO AS 3799 APPENDIX B:
 - EVIDENCE THAT AN ACCEPTABLE FINAL CONCRETE SURFACE COLOUR WILL BE OBTAINED:
 - EVIDENCE OF COMPATIBILITY WITH APPLIED FINISHES, IF ANY;
 - METHODS OF OBTAINING THE REQUIRED ADHESION FOR TOPPINGS, RENDER AND THE LIKE IF ANY.
- C13. PROTECT FRESH CONCRETE FROM PREMATURE DRYING AND FROM EXCESSIVE HOT AND COLD TEMPERATURES. MAINTAIN THE CONCRETE AT A REASONABLY CONSTANT TEMPERATURE WITH MINIMUM MOISTURE LOSS FOR THE CURING PERIOD.

REINFORCEMENT

- R1. SYMBOLS ON DRAWINGS FOR GRADE AND TYPE OF REINFORCEMENT ARE AS FOLLOWS: -
 - R GRADE 250R PLAIN ROUND BAR TO AS 1302, NORMAL DUCTILITY CLASS
 - N GRADE D500N DEFORMED BAR TO AS/NZS 4671, NORMAL DUCTILITY CLASS W - GRADE 450W PLAIN OR DEFORMED WIRE TO AS 1303. LOW DUCTILITY CLASS
 - L GRADE D500L PLAIN, DEFORMED OR INDENTED WELDED WIRE MESH TO AS/NZS 4671, LOW DUCTILITY CLASS
- R2. THE FOLLOWING ABBREVIATIONS APPLY TO THE PLACEMENT AND LOCATION OF THE
 - REINFORCEMENT: -E.W. - EACH WAY E.F. - EACH FACE N.F. - NEAR FACE
- F.F. FAR FACE BTM. - BOTTOM TYP.- TYPICAL R3. PROVIDE STANDARD HOOKS AND COGS IN ACCORDANCE WITH AS 3600. TERMINATE ENDS OF
- COLUMN AND BEAM LIGATURES IN A HOOK OF AT LEAST 135°. R4. REINFORCEMENT IS REPRESENTED DIAGRAMMATICALLY AND IS NOT NECESSARILY IN TRUE PROJECTION. SET REINFORCEMENT OUT AT EQUAL CENTRES WHERE SPACING IS NOT
- NOMINATED. R5. SECURE REINFORCEMENT, INCLUDING FITMENTS AND STARTER BARS, BY APPROVED CHAIRS, SPACERS, TIES AND THE LIKE AS REQUIRED TO PROVIDE ADEQUATE SUPPORT AND TO PREVENT DISPLACEMENT DURING SUBSEQUENT CONCRETE PLACEMENT WITHIN THE
- TOLERANCES SPECIFIED IN CLAUSE 17.5.3 OF AS 3600. R6. SPLICE REINFORCEMENT ONLY AT LOCATIONS SHOWN ON THE DRAWINGS OR AS APPROVED BY THE SUPERINTENDENT. SUBMIT DETAILS FOR APPROVAL OF ANY PROPOSED MECHANICAL
- R7. LAP LENGTHS SHALL COMPLY WITH AS 3600 OR ALTERNATIVELY WITH THE FOLLOWING PROVIDED THERE IS AT LEAST 40 mm COVER TO THE BAR AND THE CLEAR DISTANCE BETWEEN ADJACENT PARALLEL BARS DEVELOPING STRESS IS AT LEAST 80 mm: -

LOCATION	f'\[C\]	BAR SIZE							
LOOAHON	1 1[01]	N12	N16	N20	N24	N28	N32	N36	
HORIZONTAL BARS WIT	<= 25	475	750	1100	1500	1950	2450	3000	
>= 300 mm OF CONCRET	l .	375	575	850	1200	1550	1950	2350	
BELOW THE BAR	>=40	325	500	750	1050	1400	1750	2100	
	<= 25	350	575	850	1200	1550	1950	2400	
ALL OTHER BARS	32	300	450	675	950	1200	1550	1900	
	>= 40	300	400	600	850	1100	1400	1700	

LAPPED SPLICES FOR WELDED WIRE MESH SHALL BE IN ACCORDANCE WITH THE REQUIREMENTS OF CLAUSE 13.2.3 OF AS 3600.

- R8. DO NOT WELD REINFORCEMENT UNLESS SHOWN ON THE DRAWINGS OR OTHERWISE APPROVED BY THE SUPERINTENDENT. WHERE WELDING OF REINFORCEMENT IS ALLOWED. INCLUDING TACK WELDING, IT SHALL BE CARRIED OUT IN ACCORDANCE WITH THE REQUIREMENTS OF AS 3600 AND AS 1554 PART 3. DO NOT WELD REINFORCEMENT WITHIN 75 mm OF A PORTION OF THE BAR THAT HAS BEEN BENT.
- R9. DO NOT CUT, BEND NOR HEAT REINFORCEMENT ON SITE WITHOUT THE SUPERINTENDENTS
- R10. WHERE ROUND BAR DOWELS ARE SPECIFIED, THEY SHALL BE HOT DIP GALVANISED STRAIGHT, SMOOTH DOWELS FREE FROM BURRS WITH SAWN ENDS, NOT SHEARED. UNLESS NOTED OTHERWISE, INSTALL DOWELS PARALLEL TO THE FINISHED SURFACE AND PERPENDICULAR TO THE PLANE OF THE JOINT. MAINTAIN DOWEL ALIGNMENT BY THE USE OF A SUITABLE SUPPORT ASSEMBLY TO ENSURE SUITABLE HORIZONTAL AND VERTICAL ALIGNMENT TOLERANCE OF 1 IN 100. DO NOT INSERT DOWELS DURING THE PLACEMENT OF

ROCKHAMPTON REGIONAL COUNCIL **APPROVED PLANS**

These plans are approved subject to the current conditions of approval associated with

Development Permit No: D/5-2018


Dated: 15 February 2018

ISSUED FOR CONSTRUCTION

12

11

SURVEYOR DATE 0431718 CLIENT ROCKHAMPTON REGIONAL COUNCIL PROJECT TOONOOBA PARK AMENITIES AND SHADE STRUCTURE 09.11.17 REVIEWED TOONOOBA PARK AMENITIES AND SHADE STRUCTURE ADDRESS: D | 29.11.17 | AMENDED CONCRETE AND REINFORCEMENT NOTES RN SS SS GM NOTES IOTE: THIS DRAWINGS IS SOLELY THE PROPERTY OF McMURTRIE CONSULTIN C | 22.11.17 | UPDATED FOUNDATION NOTE TO INCLUDE GEOTECHNICAL RESULTS IBB SS SS GM SHEET 2 OF 2 09.11.17 RPEQ ENG ENGINEERS PTY LTD. THE INFORMATION CONTAINED IS NOT TO BE DISCLOSED CO-ORDINATE DATUM Phone: (07) 4921 1780 EPRODUCED OR COPIED IN WHOLE OR PART WITHOUT WRITTEN APPROVAL B 09.11.17 ISSUED FOR CONSTRUCTION DRAWING NUMBER SS NORTH ROCKHAMPTON QLD 4701 Mobile: 0407 631 066 FROM McMURTRIE CONSULTING ENGINEERS PTY LTD A1 | 0431718-S-0002 A 27/10/2017 SUBMITTED FOR INFORMATION PO BOX 2149, WANDAL QLD 4700 Fax: (07) 4921 1790 IBB SS D HEIGHT DATUM DFT DFT CHK DES DES CHK RPEQ No: 4525 SCALE: AS SHOWN (C) McMurtrie & Associates Pty Ltd E-mail: mail@mcmengineers.com REV DATE DRAWING No. REFERENCE DRAWING TITLE REVISION DESCRIPTION 12 10 11 5

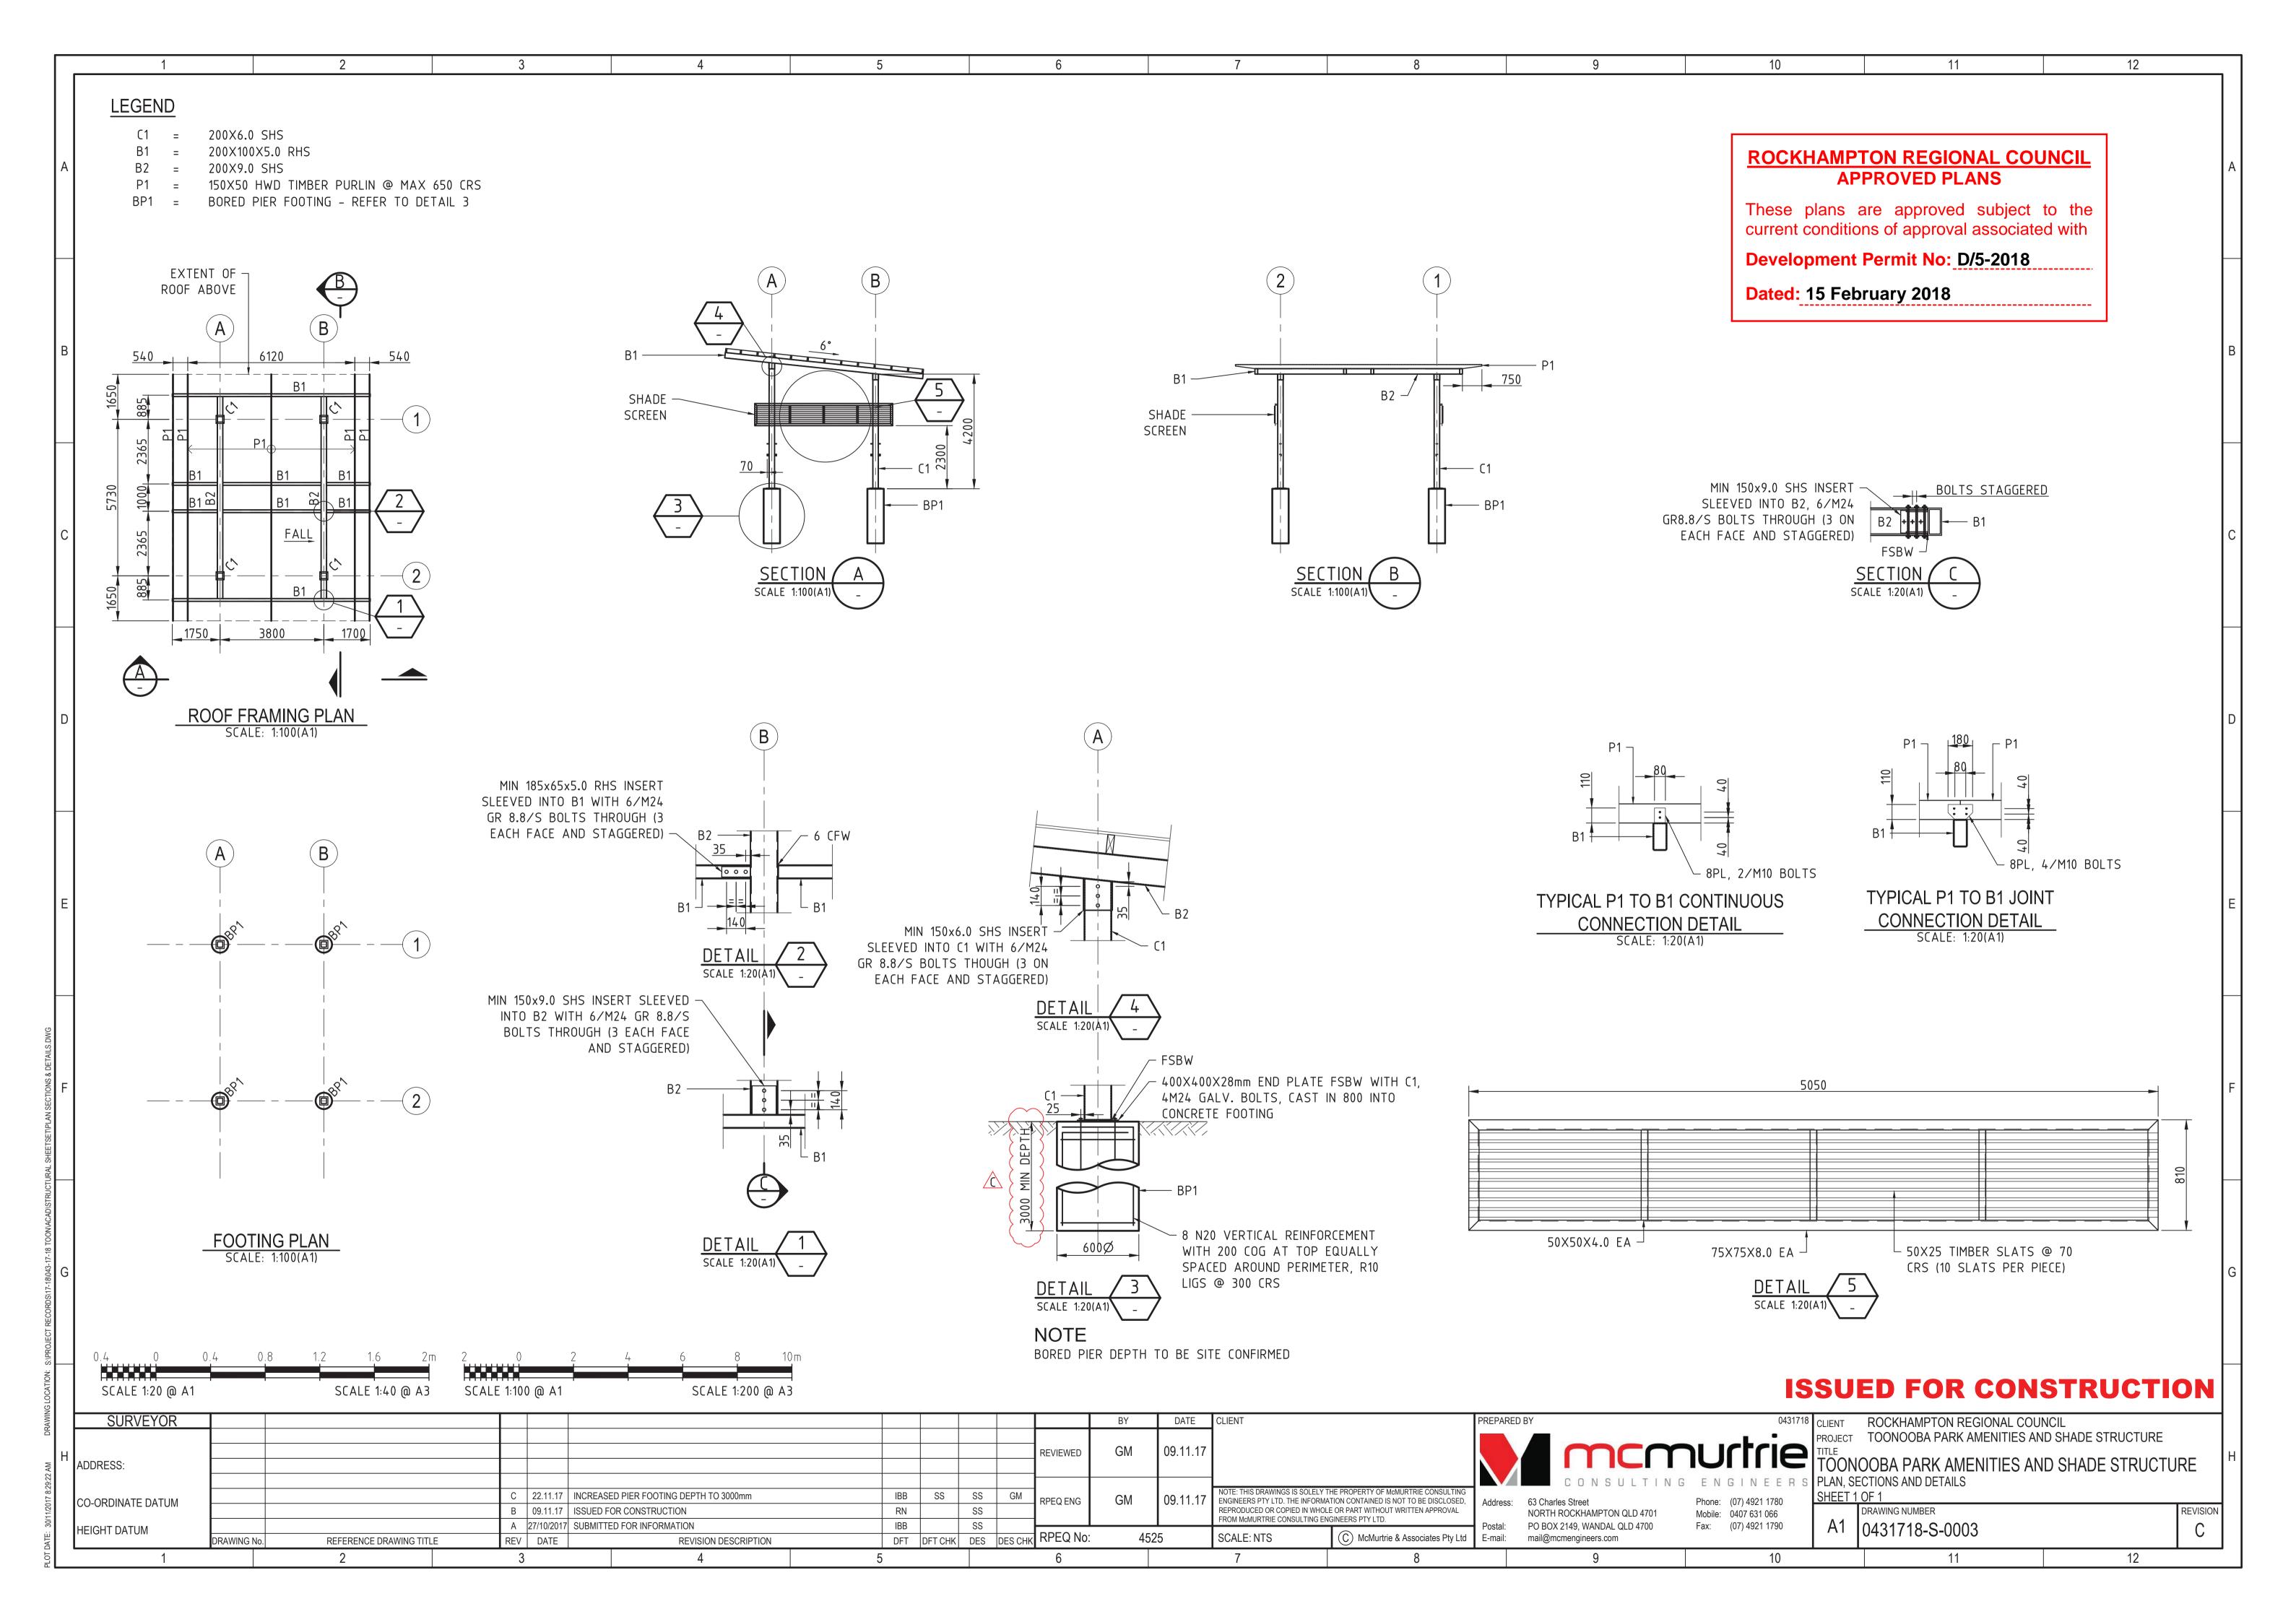

PLUMBING & DRAINAGE NOTES

1. THE WHOLE OF THE PLUMBING AND DRAINAGE WORKS SHALL BE INSTALLED IN ACCORDANCE WITH THE CURRENT NATIONAL CONSTRUCTION CODE (PLUMBING CODE OF AUSTRALIA) AND THE CURRENT PLUMBING AND DRAINAGE CODE A.S. 3500. THESE DRAWINGS ARE A GUIDE ONLY TO THE POSITION, LAYOUT AND SIZING OF THE SERVICE PIPES.

2. THE CONTRACTOR SHALL LOCATE ALL SERVICES AND CONFIRM CONNECTIONS CAN BE ACHIEVED PRIOR TO COMMENCEMENT OF WORK.

3. ALL UNDER SLAB & WALL CAVITY WATER SERVICES TO BE CLASS 'B' COPPER, BE PRE-LAGGED AND 55% OVERWRAPPED WITH 'DENSO' TAPE AND TO BE TYPE 'B' IN ACCORDANCE WITH A.S. 1432.

4. ALL EXTERNAL H.C.'s TO BE BRASS AND INSTALLED WITH A VACUUM BREAKER.

5. ANY HOSE COCKS INSTALLED ADJACENT TO URINALS TO BE FITTED WITH A SHROUD & BACKFLOW PREVENTION DEVICE.

6. ALL INTERNAL COLD WATER TO BE COPPER.

7. ALL UNDERSLAB PIPES TO BE ø100mm, GRADED AT 1:40 U.N.O.


8. ALL VENT PIPES SHALL TERMINATE ABOVE THE ROOF LEVEL IN ACCORDANCE WITH BY-LAW 111.

9. ALL INSPECTION OPENINGS AT SURFACE TO BE CAPPED AND COVERED WITH AN APPROVED REMOVABLE COVER.

GENERAL SANITARY NOTES

1. THE ACCURACY AND COMPLETENESS OF EXISTING SERVICE INFORMATION IS NOT GUARANTEED. IT IS THE CONTRACTOR'S RESPONSIBILITY TO LOCATE ALL SERVICES PRIOR TO CONSTRUCTION AND ADVISE THE SUPERINTENDANT OF ANY DIFFERENCES FROM THE DRAWINGS.

2. WHERE A JUNCTION IS TO BE MADE TO EXISTING CONSTRUCTION, THE CONTRACTOR IS TO CONFIRM THE LOCATION AND LEVEL OF THIS CONSTRUCTION PRIOR TO COMMENCING WORK ON ANY CRITICAL SECTIONS. THE SUPERINTENDENT MAY VARY LEVELS AND GRADIENTS TO ACHIEVE A SATISFACTORY CONNECTION.

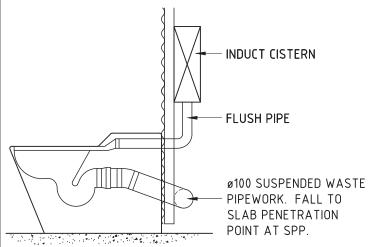

PAN CONNECTION DETAIL

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<u>DRAINAGE PLAN No.</u> <u>ITTLE</u>

<u>.</u>

(FREEHOLD / COMMUNITY TITLE)

ROCKHAMPTON REGIONAL COUNCIL APPROVED PLANS

These plans are approved subject to the current conditions of approval associated with

Development Permit No: D/5-2018

Dated: 15 February 2018

PROJECT DETAILS:

PROPERTY OWNER: ROCKHAMPTON REGIONAL COUNCIL

PROPERTY ADDRESS: 287-289 QUAY ST, ROCKHAMPTON, QLD, 4700

RP DESCRIPTION: L1 on R 26366

THIS DRAWING HAS BEEN PREPARED IN ACCORDANCE WITH AS/NZS 3500.2.1 & 2.2 2003. LANDMARK INSTALLATIONS PTY. LTD. ABN 26 129 595 044 (B.S.A LICENSE No. 1135451)

CLIENT NAME	PROJECT No.	PAGE
ROCKHAMPTON REGIONAL COUNCIL	34345	A3
PROJECT	DATE:	DRAWN
TOONOOBA PARK, QUAY STREET, ROCKHAMPTON, QLD, 4700	05/12/17	JEO
MOD K9504 "CARETAKER" 2D (SKILLION) RESTROOM	DRAWING No.	SCALE
HIGD 13304 CAILLANLIN 2D (SKILLION) INCOM	34345	AS NTD
DRAWING TITLE	SHEET No.	REV.
BA - HYDRAULIC LAYOUT	301	1

LEGEND CLEANOUT TO SURFACE C۷ CHECK VALVE HB HAND BASIN HBP HAND BASIN WITH "P" TRAP HC HOSE COCK 10 INSPECTION OPENING 105 INSPECTION OPENING TO SURFACE OVERFLOW RELIEF GULLY ORG 500 KPa PRESSURE REDUCTION VALVE SLAB PENETRATION POINT V50 VENT 50 TOILET 100 uPVC PROPOSED SEWER (IN GROUND) 100 uPVC - PROPOSED SEWER (SUSPENDED) ---- PROPOSED WATER SUPPLY NOTE: ALL PLUMBING INDICATED IS FOR GUIDANCE PURPOSES ONLY NOTE: NO JOINS PERMITTED IN WATER SERVICE UNDER SLAB

500x420 S/S BASIN

ROCKHAMPTON REGIONAL COUNCIL APPROVED PLANS


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Development Permit No: D/5-2018

Dated: 15 February 2018

DRAINAGE PLAN No.

<u>.</u>

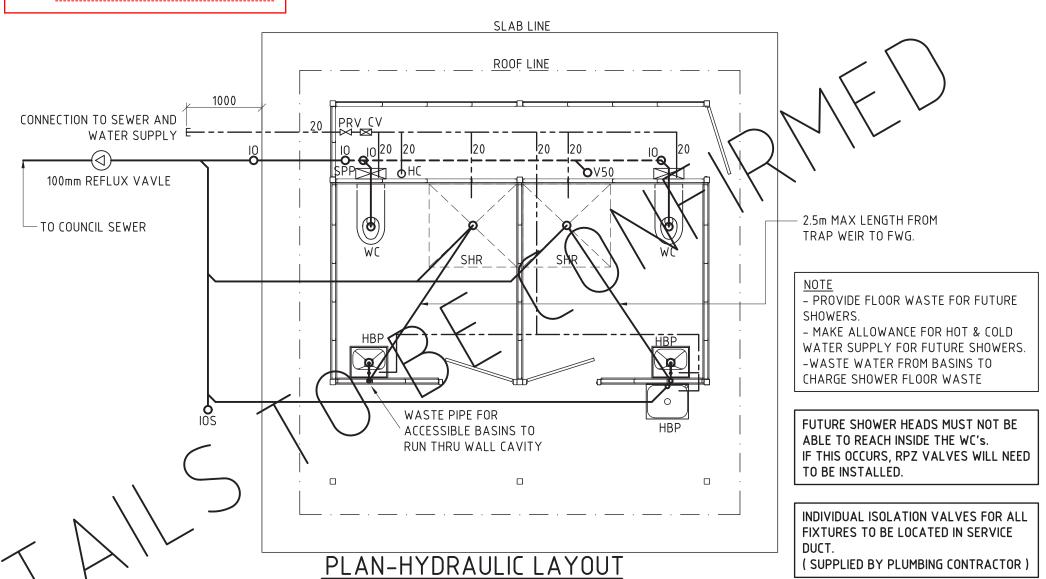

ALL DIMENSIONS IN MILLIMETRES - DO NOT SCALE

SCALE 1:50

PROJECT DETAILS:

PROPERTY OWNER: ROCKHAMPTON REGIONAL COUNCIL

PROPERTY ADDRESS: 287-289 QUAY ST, ROCKHAMPTON, QLD, 4700

RP DESCRIPTION: L1 on R 26366

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BASIN DETAIL SCALE 1:20 EVISION

NO PIPES — ALLOWED IN

THIS ZONE

200

KNEE/TOE?

CLEARANCE

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2		-	-	CHECKED BY:	DATE:			
1	PLUMBING DETAILS CORRECTED	18/12/17	MAF					

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Queensland 4508	landmark@landmarkpro.com.au

CLIENT NAME	PROJECT No.	PAGE
ROCKHAMPTON REGIONAL COUNCIL	34345	A3
PROJECT	DATE:	DRAWN
TOONOOBA PARK, QUAY STREET, ROCKHAMPTON, QLD, 4700	05/12/17	JEO
MOD K9504 "CARETAKER" 2D (SKILLION) RESTROOM	DRAWING No. 34345	SCALE AS NTD
DRAWING TITLE	SHEET No.	REV.
BA - HYDRAULIC LAYOUT	302	<u> </u>

TOONOOBA PARK


AMENITIES BLOCK AND SHADE STRUCTURE

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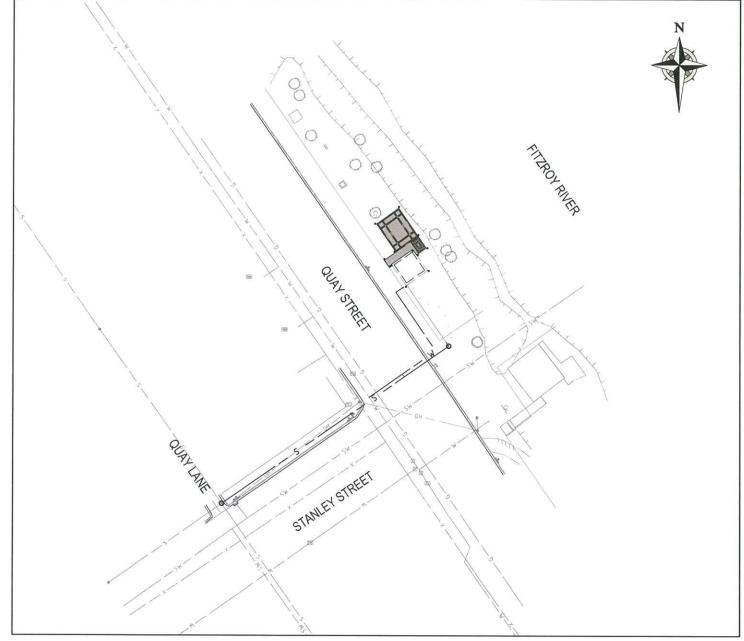
Dated: 15 February 2018



DRAWING SCHEDULE							
DRAWING No.	DESCRIPTION	REVISION					
0431718-0001	TITLE SHEET - SHEET 1 OF 1	A					
0431718-0002	SEWERAGE LAYOUT & LONGITUDINAL SECTION - SHEET 1 OF 1	A					


GENERAL NOTES

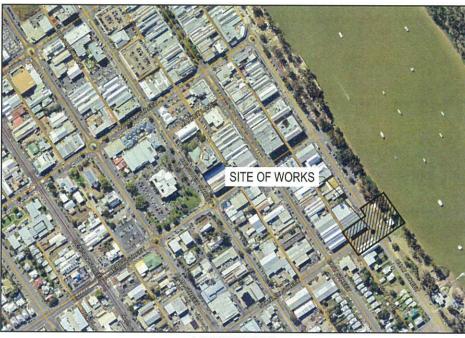
- ALL WORKS SHALL BE CARRIED OUT IN ACCORDANCE WITH THE ROCKHAMPTON REGIONAL COUNCIL STANDARD SPECIFICATIONS AND DRAWINGS UNLESS STATED OTHERWISE.
- ALL PLUMBING AND DRAINAGE WORKS ARE TO BE CARRIED OUT IN ACCORDANCE WITH CMDG STANDARDS, THE 'BUILDING ACT' (1975), AND THE 'PLUMBING AND DRAINAGE ACT' (2002).
- 3. ALL WORKS ARE TO BE COMPLETED BY SUITABLY QUALIFIED TRADES PEOPLE.
- THE CONTRACTOR IS RESPONSIBLE FOR COMPLYING WITH ALL REQUIRED TESTING REQUIREMENTS SET OUT
- ALL MEASUREMENTS ARE PROVIDED IN METERS U.N.O.
 ALTHOUGH THE PRESENT AND/OR PROPOSED POSITIONS OF PUBLIC UTILITIES, FITTINGS, MANHOLES, POLES, ETC MAY BE INDICATED ON THE DRAWINGS, THE CONTRACTOR SHALL VERIFY THE LOCATION AND DEPTH OF ALL EXISTING SERVICES WITH THE RELEVANT AUTHORITIES BEFORE COMMENCEMENT OF ANY WORK. ANY COST ASSOCIATED WITH REPAIRING DAMAGE TO EXISTING SERVICES SHALL BE PAID FOR BY THE
- 7. A TELSTRA REPRESENTATIVE MUST BE PRESENT WHEN EXCAVATING NEAR TO TELSTRA CABLES.
- 8. STOCKPILING OF REUSABLE MATERIAL SHALL BE AT A LOCATION APPROVED BY THE SUPERINTENDENT ON SITE, AND SHALL BE WATERED DOWN TO ENSURE THAT DUST IS KEPT TO A MINIMUM.
- 9. TURF IS TO BE APPLIED TO ALL DISTURBED AREAS.
- 10. IN ACCORDANCE WITH THE REQUIREMENTS OF THE WORKPLACE HEALTH AND SAFETY ACT, THE CONTRACTOR SHALL UNDERTAKE A SAFETY IN DESIGN (SID) RISK ASSESSMENT FOR THE DESIGN.



GENERAL LAYOUT PLAN SCALE: 1:500(A1) 1:1000(A3)

SCALE 1:500 @ A1	SCALE 1:1 000 @ A3												IS	SUED FOR CONSTRUCTION
SURVEYOR							BY	DATE	CLIENT		PREPAREI	D BY	0431718	CLIENT ROCKHAMPTON REGIONAL COUNCIL
H ADDRESS: 232 BOLSOVER STREET ROCKHAMPTON QLD 4700						REVIEW	photo	-29.11.17	1			mc m	nurtrie	PROJECT TOONOOBA PARK AMENITIES TITLE TOONOOBA PARK AMENITIES
ROCKHAMPTON QLD 4700	CMDG-S-090 SEWER CONSTRUCTION - PIPELINE CONSTRUCTION TYPES						1 .1					CONSULTIN	G ENGINEERS	TITLE SHEET
CO-ORDINATE DATUM	CMSG-S-030 HOUSE CONNECTION BRANCHES	C 29.11.17	AMENDED SITE LAYOUT	RN	KLF	RPEQ EN	11111	79-11-17	NOTE: THIS DRAWINGS IS SOLELY T	THE PROPERTY OF McMURTRIE CONSULTING		00.01 - 1 - 01 - 1	The second second second	
CO-ORDINATE DATUM MGA94 ZONE 56	CMDG-S-021 ACCESS CHAMBERS - 1050 NOM. DIA. PRECAST COMP.	B 09.11.17	ISSUED FOR CONSTRUCTION	RN	KLF	THE EST EN	W.W.	1	REPRODUCED OR COPIED IN WHOLE	E OR PART WITHOUT WRITTEN APPROVAL	Address:	63 Charles Street NORTH ROCKHAMPTON QLD 4701	Phone: (07) 4921 1780 Mobile: 0407 631 066	DRAWING NUMBER REV
HEIGHT DATUM	CMDG-S-023 ACCESS CHAMBERS - ALTERNATIVE DROPS	A	SUBMITTED FOR INFORMATION						FROM McMURTRIE CONSULTING EN	GINEERS PTY LTD.	Postal:	PO BOX 2149, WANDAL QLD 4700	Fax: (07) 4921 1790	7.37
AHD	DRAWING No. REFERENCE DRAWING TITLE	REV DATE	REVISION DESCRIPTION	DFT DFT CI	K DES DES	CHK RPEQ	No: 15243	\$	SCALE: NTS	McMurtrie & Associates Pty Ltd	E-mail:		100. (07) 4321 1730	A1 0431718-0001

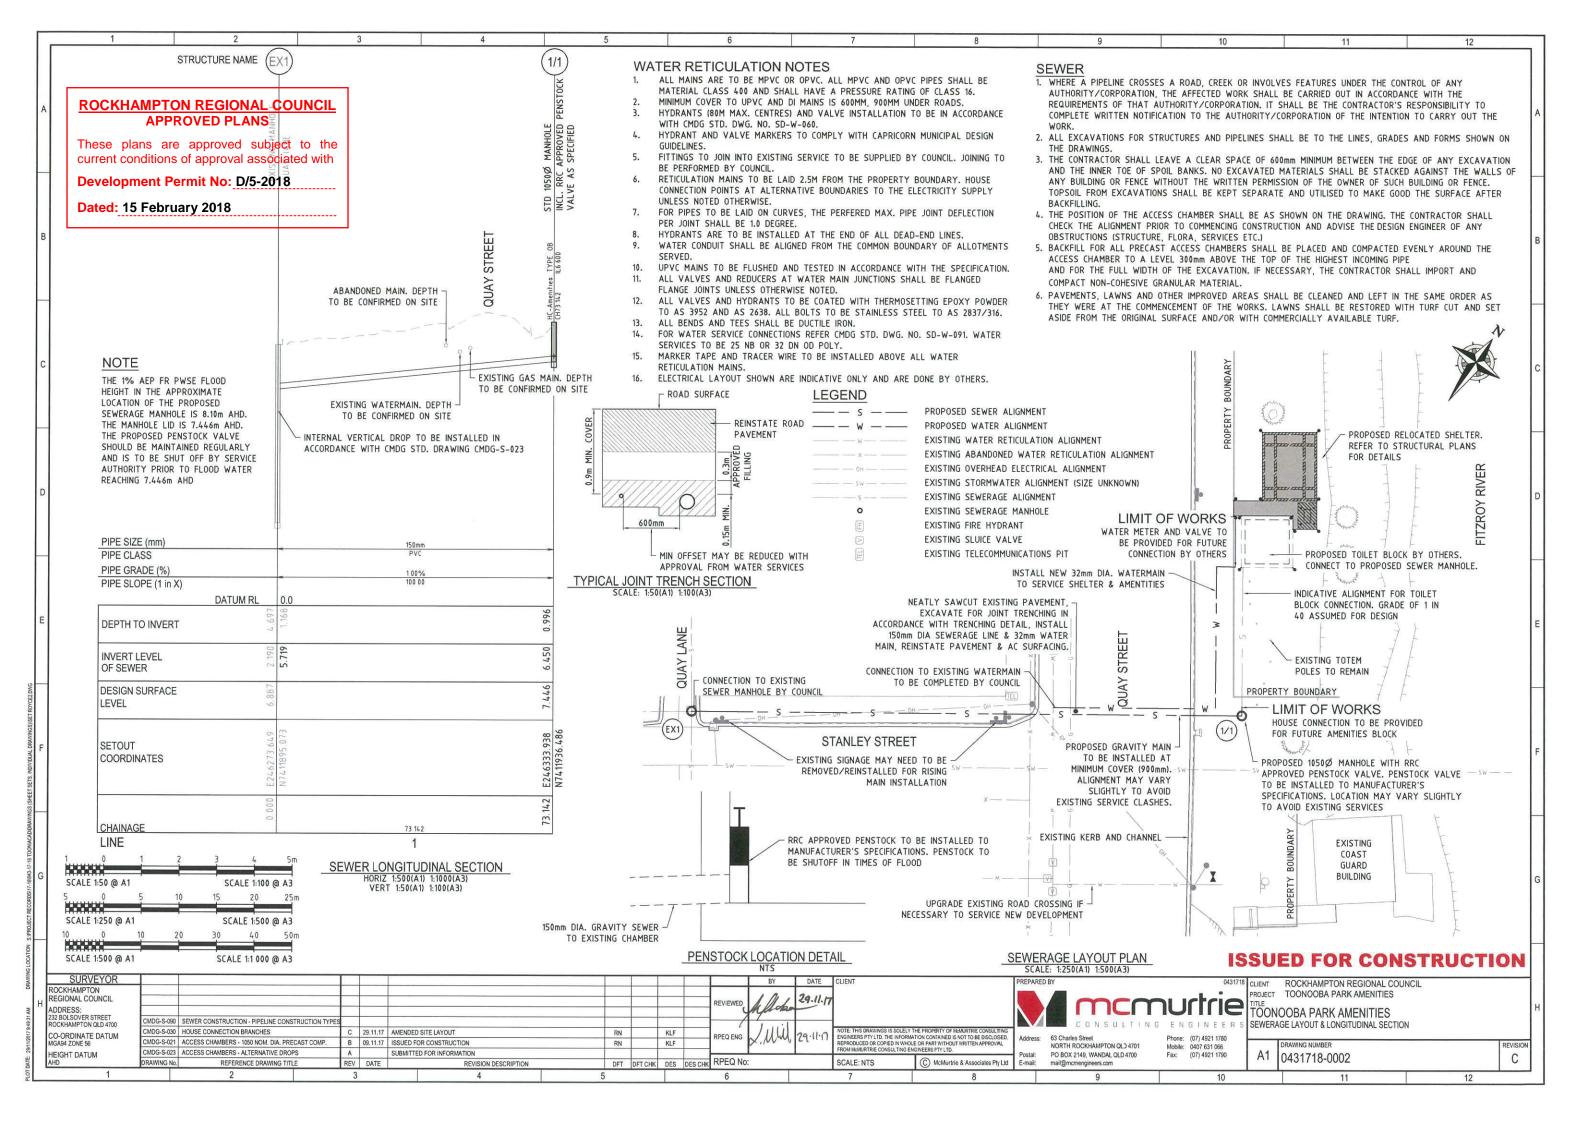

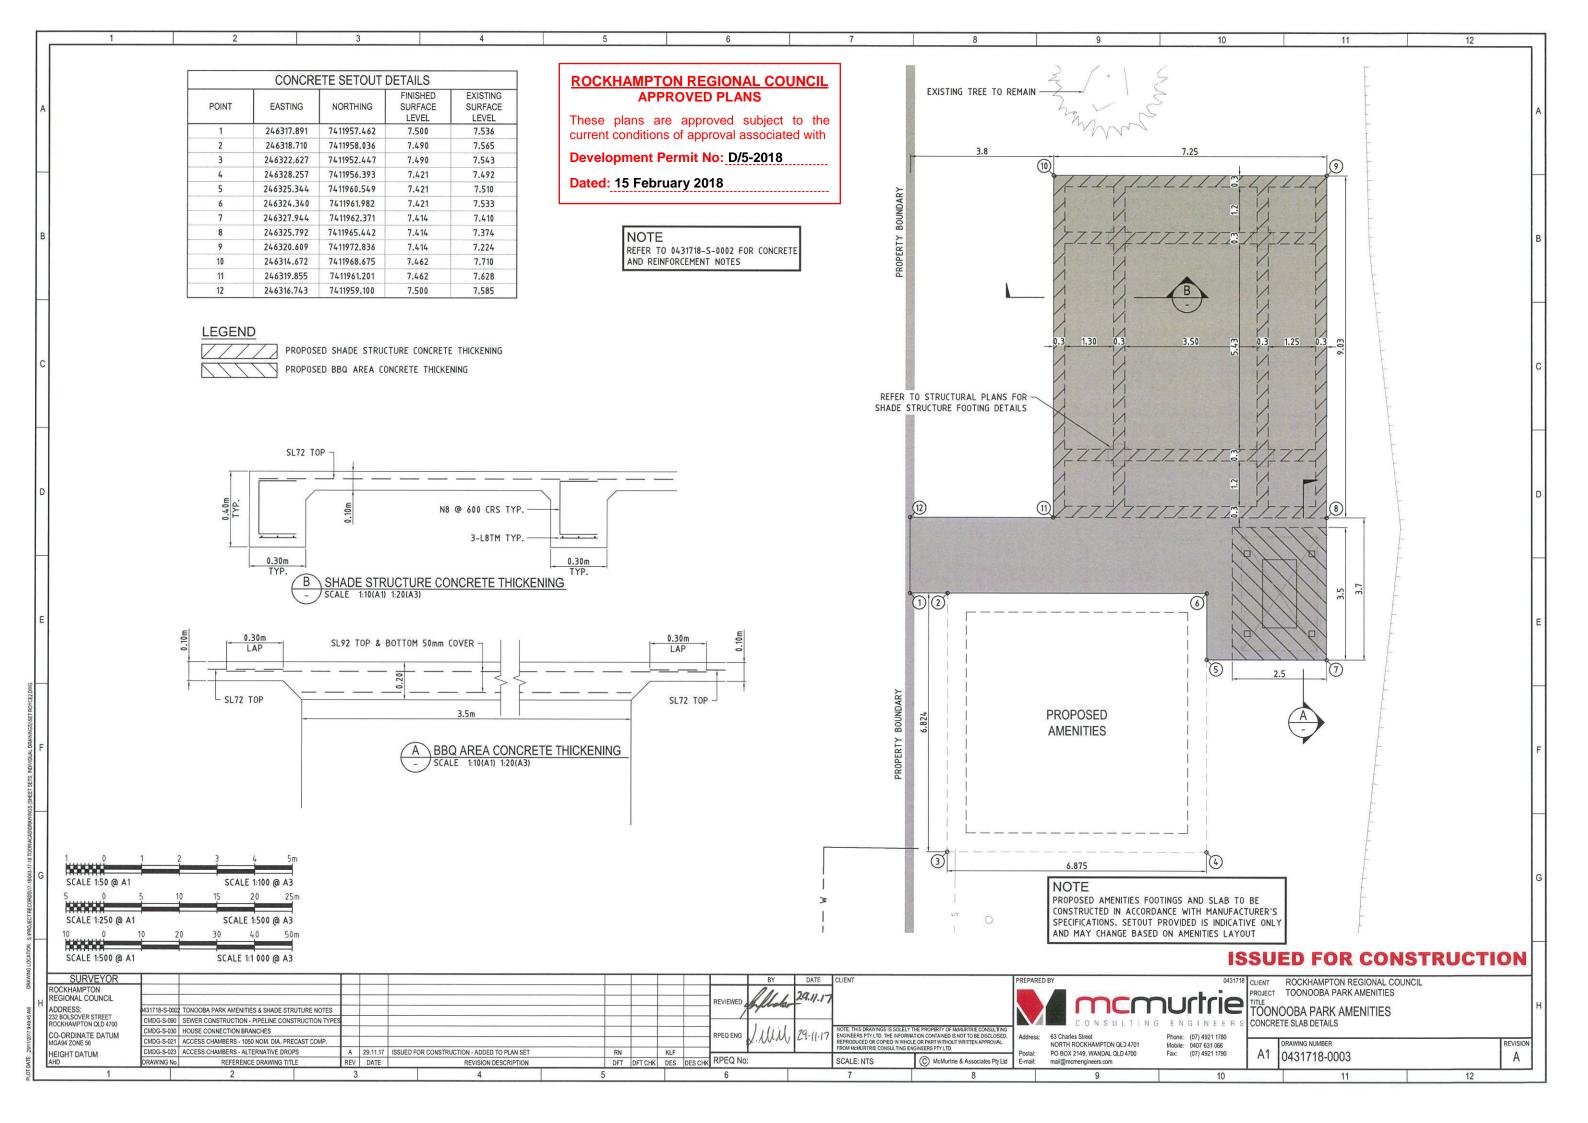

ROCKHAMPTON REGIONAL COUNCIL APPROVED PLANS

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Dated: 15 February 2018

DOOR LEGEND

D1-2045x925 COLORBOND CLAD **SOLIDCORE** DOOR-STEEL FRAME D2-2045x925 COLORBOND CLAD **SOLIDCORE** DOOR-STEEL FRAME. cw 3 DEAD LOCKS, TOP, MIDDLE & BOTTOM OF DOOR.

LEGEND (Landmark supply)

WD = STAINLESS STEEL DISABLED COMPLIANT PAN

ID = INDUCT PLASTIC CISTERN

BA = STODDART WB.K02.300 STAINLESS STEEL BASIN, KNEE OPERATED, SHROUDED PLUMBING, 300mm SPLASHBACK CW TIMED FLOW COLD WATER SECURITY BUBBLER.

CS = STODDART CS.03.SECURE.450 STAINLESS STEEL CLEANERS SINK (NO SINK GRATE REQ'D), SHROUDED PLUMBING, 450mm SPLASHBACK, TIMED FLOW BUTTON TAP.

BTS = BRAILLE TACTILE SIGNAGE

DR = DISABLED COMPLIANT RAILS CW BACKREST

TRH = TOILET ROLL HOLDER

HC = VANDAL PROOF HOSE COCK (NOTE: ₹ INCH REQ'D)

VL = THORN GLADIATOR LED VANDAL LIGHTS

LEGEND (Rockhampton RC supply)

SH = STAINLESS STEEL SHELF

CH = COAT HOOK

DGPO = DOUBLE GENERAL POWER OUTLET

NOTE: FLOOR FINISH (BY RRC) IN CUBICLES & SERVICE DUCT TO BE SEAMLESS EPOXY FINISH.

-ALL WALLS TO 2100 HIGH UNLESS NOTED.

-EXTERNAL WALL TO SERVICE DUCT TO 2190 HIGH. -INTERNAL WALL BETWEEN SERVICE DUCT AND

CUBICLES TO 2360 HIGH.

-INTERNAL WALL BETWEEN CUBICLES TO 2360 HIGH. -EXTERNAL WALL TO CUBICLES TO HAVE ALUMINIUM

-ALL WALLS TO HAVE 50 GAP UNDER.

*POTENTIAL FUTURE SHOWERS TO HAVE ALLOWANCE

VENTILATION SCREEN OVER. → SLAB LINE

 $\langle 2 \rangle$

MADE FOR PLUMBING SUPPLY (WASTE AND H&C WATER). WALL NOGGING (FOR FIXTURES & SEAT), SLAB FALLS ETC.

APPROVED

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MAF

18/12/17

2413

SERVICE DUCT

TRH

75

400

PLAN

500

HC DGP0

ACCESSIBLE

٧L

2400

BĪS

(D1)

5025

5825 O/A ROOF

6825 O/A SLAB

75

400 75

6875 0/A SLAB

5875 0/A ROOF

75

75

1240

40075

AMENDMENTS AS PER CLIENTS MARK UP

500

5

4

3

2

ROOF LINE

2413

* POTENTIAL

UNISEX

ACCESSIBLE

VL

2400

(D1)

FUTURE SHOWERS

50

(D2)

75

400

500

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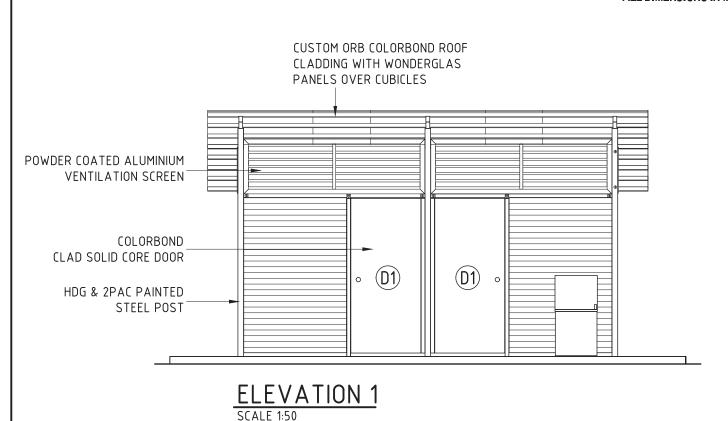
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DRAW BA

CLIENT NAME		PR	OJECT No.	PAGE
ROCKHAMPTON REGIO	34	345	A3	
PROJECT	DA	TE:	DRAWN	
TOONOOBA PARK, QUAY	05	/12/17	JEO	
MOD K9504 "CARETAK		AWING No.	SCALE	
MOD 10007 OAKETAK	LIC 25 (CICLEIOII) ILCOIRCOIN	34	345	NOTED
DRAWING TITLE		SH	EET No.	REV.
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CLIENTS DESIGN APPROVAL

DATE:



ROCKHAMPTON REGIONAL COUNCIL APPROVED PLANS


These plans are approved subject to the current conditions of approval associated with

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Dated: 15 February 2018

GENERAL NOTES:

- 1. DURING CONSTRUCTION THE STRUCTURE SHALL BE MAINTAINED IN A STABLE CONDITION AND NO PART SHALL BE OVER STRESSED.
- 2. PRIOR TO COMMENCEMENT OF WORKS THE BUILDER SHALL SATISFY THEMSELVES OF THE CORRECT LOCATIONS OF ALL EXISTING SERVICES WHETHER INDICATED OR NOT ON THE PLANS.
- 3. LOCATING OF THE STRUCTURE, INCLUDING CO-ORDINATES IF APPLICABLE, IS THE RESPONSIBILITY OF THE CLIENT AND/OR THE CLIENT'S SITE REPRESENTATIVE.
- 4. STRUCTURE HAS BEEN DESIGNED IN ACCORDANCE TO THE FOLLOWING AUSTRALIAN STANDARDS:
 - AS1170.1, AS1170.2, AS1720.1, AS3600 AND AS4100, AS1664.
- 5. STRUCTURE IS SUITABLE FOR **C2** AREAS AND HAS BEEN DESIGNED WITH AN AVERAGE RECURRENCE INTERVAL OF **200** YEARS. STRUCTURE IS ALSO DESIGNED TO TAKE AN AEP 1% (8.096 AHD) WITH A VELOCITY OF 0.503m/s, BASED ON THE SITE LEVEL GROUND AVERAGE OF 7.5 AHD.
- 6. SITE COVERAGE IS 34.22m2 (ROOF AREA).
- 7. THE FOOTING HAS BEEN DESIGNED ASSUMING:
 - SITE CLASS P (DUE TO FILL)
 - ALLOWABLE SOIL BEARING CAPACITY OF 100kPa
 - SOIL ADHESION OF 10kPa
- (TO BE VERIFIED ON SITE).
- 8. FOR SLABS ON GROUND, ALL TOPSOIL AND UPPER STRATA CONTAINING SOFT OR ORGANIC MATTER ARE TO BE REMOVED AND REPLACED WITH SELECT COMPACTED FILL.
- 9. ALL FILL TO BE CLEAN, PLACED IN LAYERS NOT EXCEEDING 200mm AND COMPACTED TO 95% STANDARD COMPACTION.
- 10. EARTHWORKS SHALL BE CARRIED OUT IN ACCORDANCE WITH CRITERIA AND PROCEDURES SET OUT IN AS3798 GUIDELINES ON EARTHWORKS FOR COMMERCIAL AND RESIDENTIAL DEVELOPMENTS.

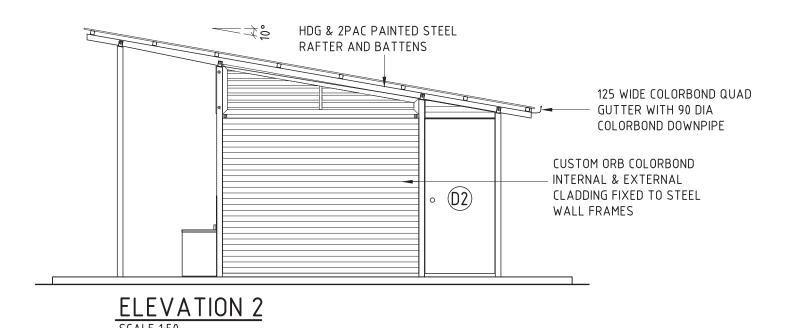

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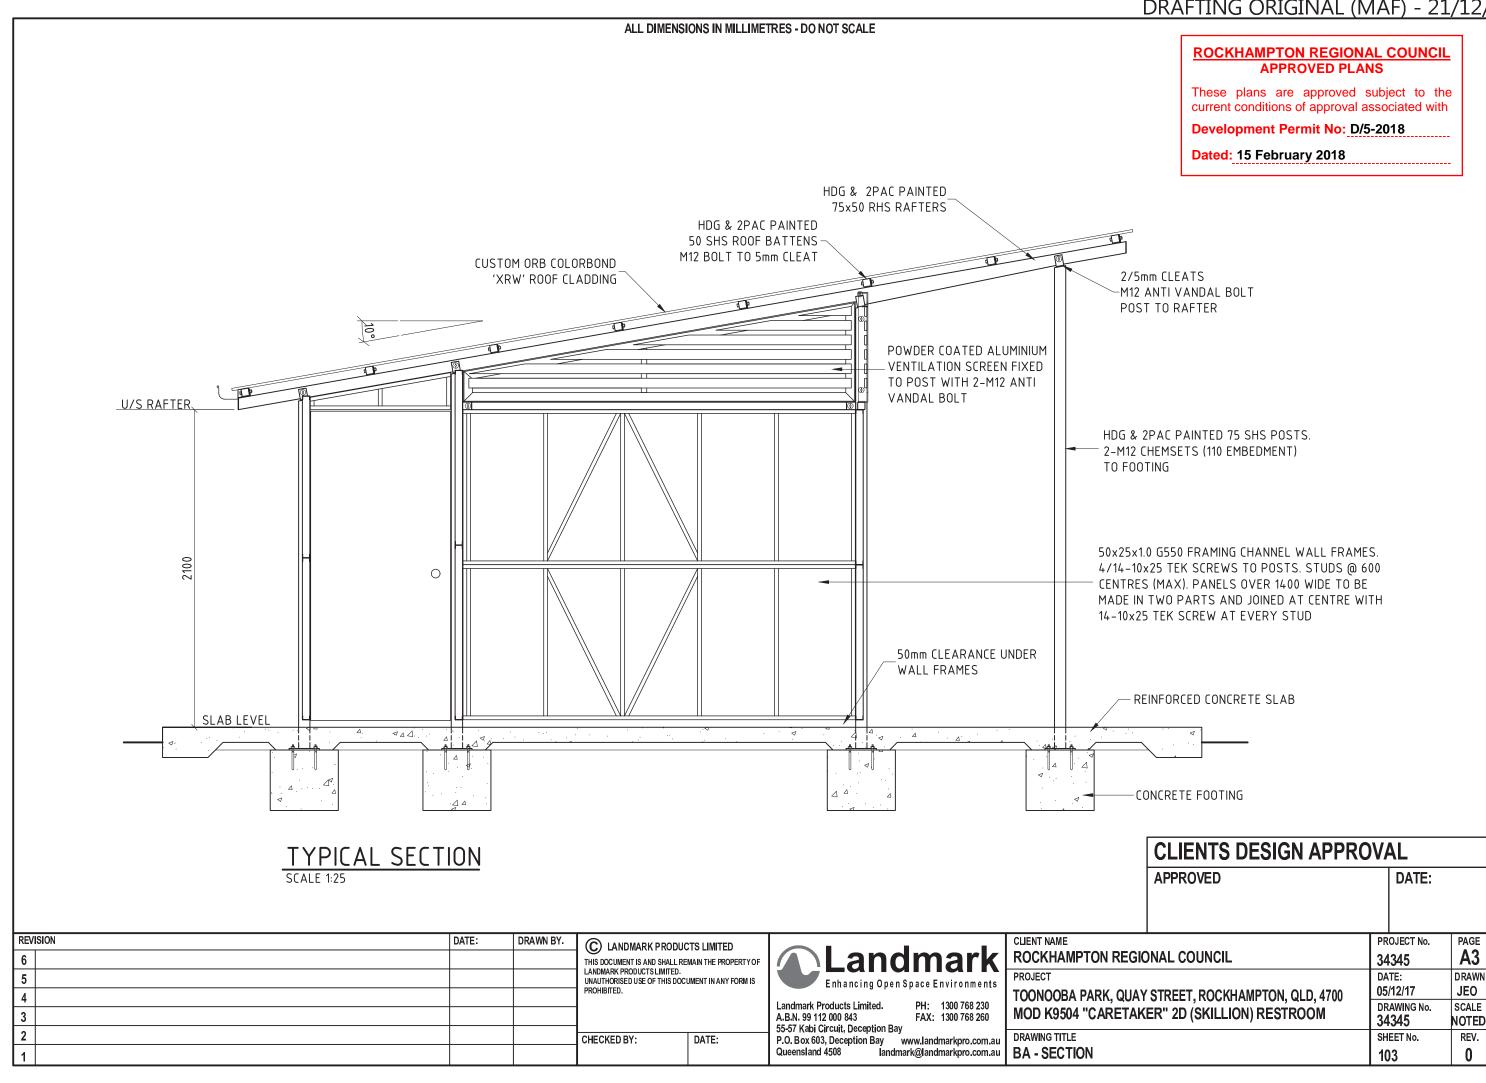
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	CLIENT NAME		PR	OJECT No.	PAGE
<	ROCKHAMPTON REGIO	NAL COUNCIL	34	1345	A3
ıts	PROJECT			TE:	DRAWN
	TOONOOBA PARK, QUAY	STREET, ROCKHAMPTON, QLD, 4700	05	/12/17	JE0
)		ER" 2D (SKILLION) RESTROOM		AWING No. 1345	SCALE NOTED
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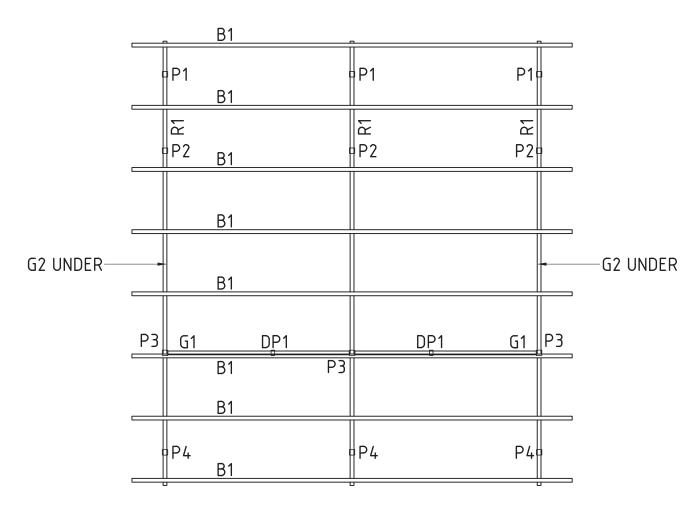


ROCKHAMPTON REGIONAL COUNCIL APPROVED PLANS

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FRAMING LAYOUT

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CLIENT NAME	PROJECT No.	PAGE
ROCKHAMPTON REGIONAL COUNCIL	34345	A3
PROJECT	DATE:	DRAWN
TOONOOBA PARK, QUAY STREET, ROCKHAMPTON, QLD, 4700	05/12/17	JE0
MOD K9504 "CARETAKER" 2D (SKILLION) RESTROOM	DRAWING No.	SCALE
WOD N9304 CANLTANEN 2D (SNILLION) NESTROOM	34345	NTS
DRAWING TITLE	SHEET No.	REV.
BA - FRAMING PLAN	201	0

STRUCTURAL NOTES:

S1. UNLESS NOTED OTHERWISE, ALL TIMBER IS SPECIFIED AS FOLLOWS:-ALL PINE TIMBER TO BE LOSP TREATED MGP12. ALL HARDWOOD TIMBER TO BE ACQ TREATED F17 HARDWOOD. ALL MACHINED / CUT SURFACES TO BE SUITABLY RETREATED WITH A LANDMARK PRODUCTS APPROVED COMPOUND.

- S2. UNLESS NOTED OTHERWISE, ALL STEEL TO BE:
 - PLATES: GRADE 250, HOT DIP GALVANISED
 - SHS/RHS/CHS: GRADE 350, HOT DIP GALVANISED
 - HOT ROLLED SECTIONS: GRADE 300, HOT DIP GALVANISED
 - FIXINGS: **STAINLESS STEEL** EXCLUDING CL4 CLADDING SCREWS
- S3. UNLESS NOTED OTHERWISE, ALL WELDS TO BE 5mm CONTINUOUS FILLET, CATEGORY GP, FROM E48xx ELECTRODES OR W50x WIRE.
- S4. ALL STEEL AND TIMBER TO BE FABRICATED AND ERECTED WITH GOOD BUILDING PRACTICE AND IN ACCORDANCE WITH AS4100, AS1554, AS1720 AND AS1684.1.

FRAMING LEGEND:

P1-P4: 75x3 SHS POST, FIXED TO FOOTING WITH 10 THK BASEPLATE C/W 2-M12 CHEMSET (110 EMBEDMENT)

DP1: 75x3 SHS DOOR POST, FIXED TO FOOTING WITH 10 THK BASEPLATE C/W 2-M12 CHEMSET (110 EMBEDMENT).

R1: 75x50x3 RHS RAFTER FIXED TO POST WITH 2-50x5 PLATES C/W 1-M12 ANTI VANDAL BOLT.

B1: 50x3 SHS ROOF BATTEN FIXED TO POST WITH 1-50x5 PLATE C/W 1-M12 BOLT.

G1-G2: 50x2 SHS GIRT FIXED TO POST WITH 2-50x5 PLATE C/W 1-M12 ANTI VANDAL BOLT. FIXED TO DOOR POST WITH 2-50x5 PLATES C/W 1-M12 ANTI VANDAL BOLT.

DRAFTING ORIGINAL (MAF) - 21/12/17

THICKENING


M12 CHEMSETS

110 EMBEDMENT

CONCRETE

CONCRETE NOTES:

- 1. UNLESS NOTED OTHERWISE, ALL FOOTINGS TO BE FOUNDED 200mm INTO NATURAL GROUND OR CERTIFIED FILL
- 2. UNLESS NOTED OTHERWISE, CONCRETE TO BE 32MPa, 40mm COVER.
- 3. CONCRETE COVER TO BE MAINTAINED BY THE USE OF APPROVED CHAIRS AND/OR CONCRETE BLOCKS SPREAD AT APPROXIMATELY 600mm CROSS CENTRES.
- 4. CONSTRUCTION JOINTS WHERE NOT SHOWN SHALL BE LOCATED TO THE APPROVAL OF THE ENGINEER.
- 5. NO HOLES OR CHASES OTHER THAN THOSE SHOWN ON THE STRUCTURAL DRAWINGS SHALL BE MADE IN CONCRETE MEMBERS WITHOUT THE PRIOR APPROVAL OF THE ENGINEER.
- 6. ALL CONCRETE SURFACES ARE TO BE CURED BY AN APPROVED METHOD FOR SEVEN DAYS IMMEDIATELY AFTER CONCRETE IS PLACED.
- 7. ALL CONCRETE TO BE MECHANICALLY VIBRATED DURING PLACEMENT.
- 8. ALL WORKMANSHIP AND MATERIALS SHALL BE IN ACCORDANCE WITH CURRENT RELATIVE CODES IN PARTICULAR AS3600 CONCRETE STRUCTURES.
- 9. REINFORCMENT LAPS TO BE AS FOLLOWS:
 - FABRIC: 2 CROSS WIRES + 25mm TRENCH MESH: 450mm
- N12 BAR: 500mm N16 BAR: 600mm
- N20 BAR: 800mm N24 BAR: 1000mm
- 10. SLAB DIMENSIONS SHOWN ARE TO 500mm PAST ROOF LINE OF BUILDING. CLIENT TO DETERMINE FINAL DIMENSIONS.

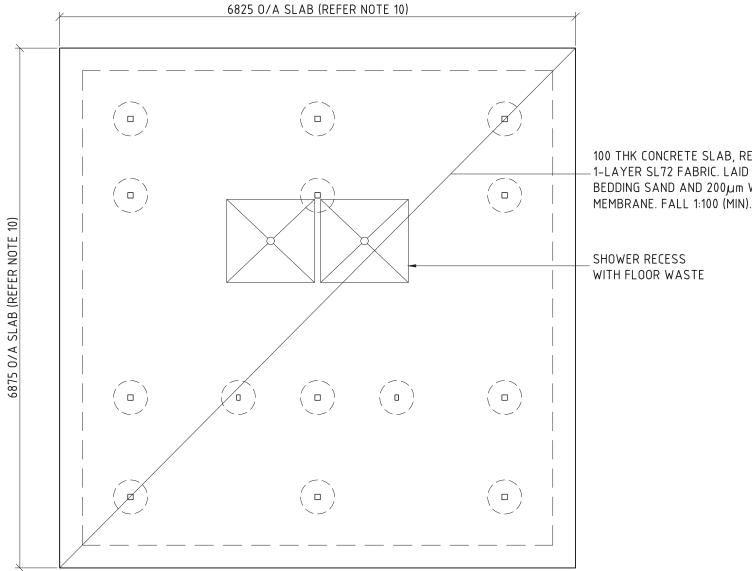

100 THK CONCRETE SLAB, REINF, WITH 1-LAYER SL72 FABRIC. LAID ON 50 BEDDING SAND AND 200µm WATERPROOF

SHOWER RECESS WITH FLOOR WASTE

SOIL REPORT: **BUTLER PARTNERS** PROJECT No. R17-204A

ALL DIMENSIONS IN MILLIMETRES - DO NOT SCALE

FOOTING 450ø FOOTING DETAIL

CONCRETE SLAB


200µm

WATERPROOF

50mm SAND BED

MEMBRANE

SCALE 1:20 FINISHED SLAB LEVEL - ASSUMED 0.00 PL - PAD LEVEL

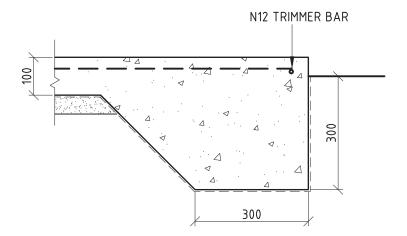

EDGE BEAM DETAIL

ROCKHAMPTON REGIONAL COUNCIL APPROVED PLANS

These plans are approved subject to the current conditions of approval associated with

Development Permit No: D/5-2018

Dated: 15 February 2018

SLAB LAYOUT

REV	SION	DATE:	DRAWN BY.	C LAND
6	•	-	-	THIS DOCUME
5	•	-	-	LANDMARK PR UNAUTHORISE
4		-	-	PROHIBITED.
3	•	-	-	
2	•	-	-	CHECKED B
1	SOIL REPORT REFERENCED, FOOTING & EDGE BEAM AMENDED	18/12/17	MAF	

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Landmark Products Limited. A.B.N. 99 112 000 843 55-57 Kabi Circuit, Deception Bay BY: DATE: P.O. Box 603, Deception Bay www.landmarkpro.com.au Queensland 4508 landmark@landmarkpro.com.au

Landmark
Enhancing Open Space Environments

CLIENT NAME **ROCKHAMPTON REGIONAL COUNCIL** TOONOOBA PARK, QUAY STREET, ROCKHAMPTON, QLD, 4700 PH: 1300 768 230 MOD K9504 "CARETAKER" 2D (SKILLION) RESTROOM FAX: 1300 768 260 DRAWING TITLE **BA - SLAB PLAN**

PROJECT No. PAGE **A3** 34345 DATE: DRAWN 05/12/17 **JEO** DRAWING No. SCALE 34345 AS NTD SHEET No. REV. 202