




PROPOSED OPTUS
BASE STATION

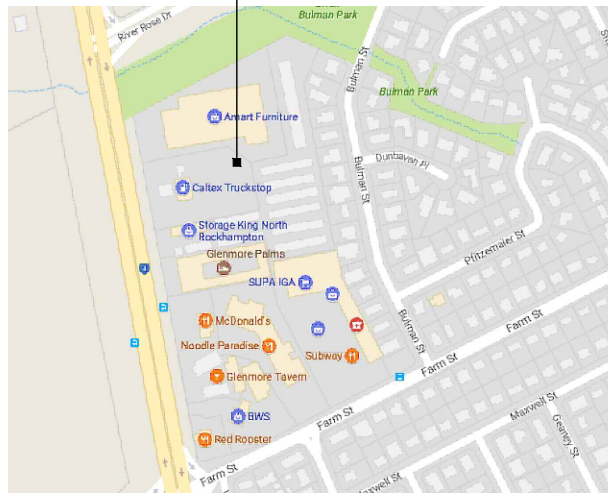

LOCALITY MAP
COPYRIGHT © GOOGLE MAPS

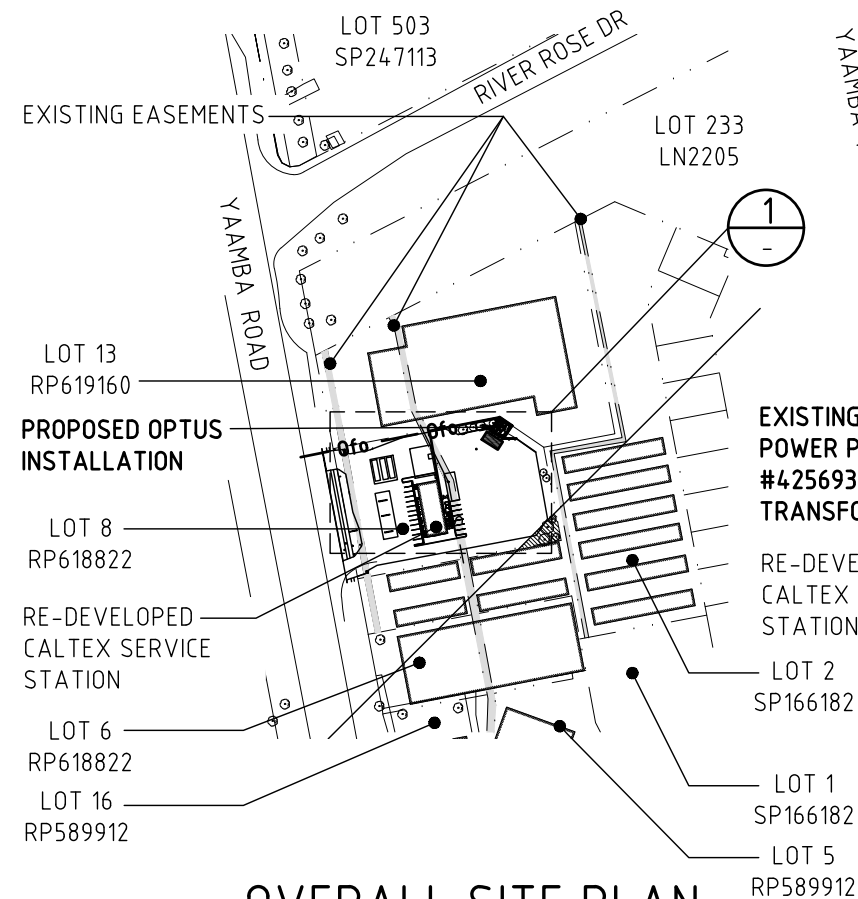

OVERALL SITE PLAN
SCALE 1:4000

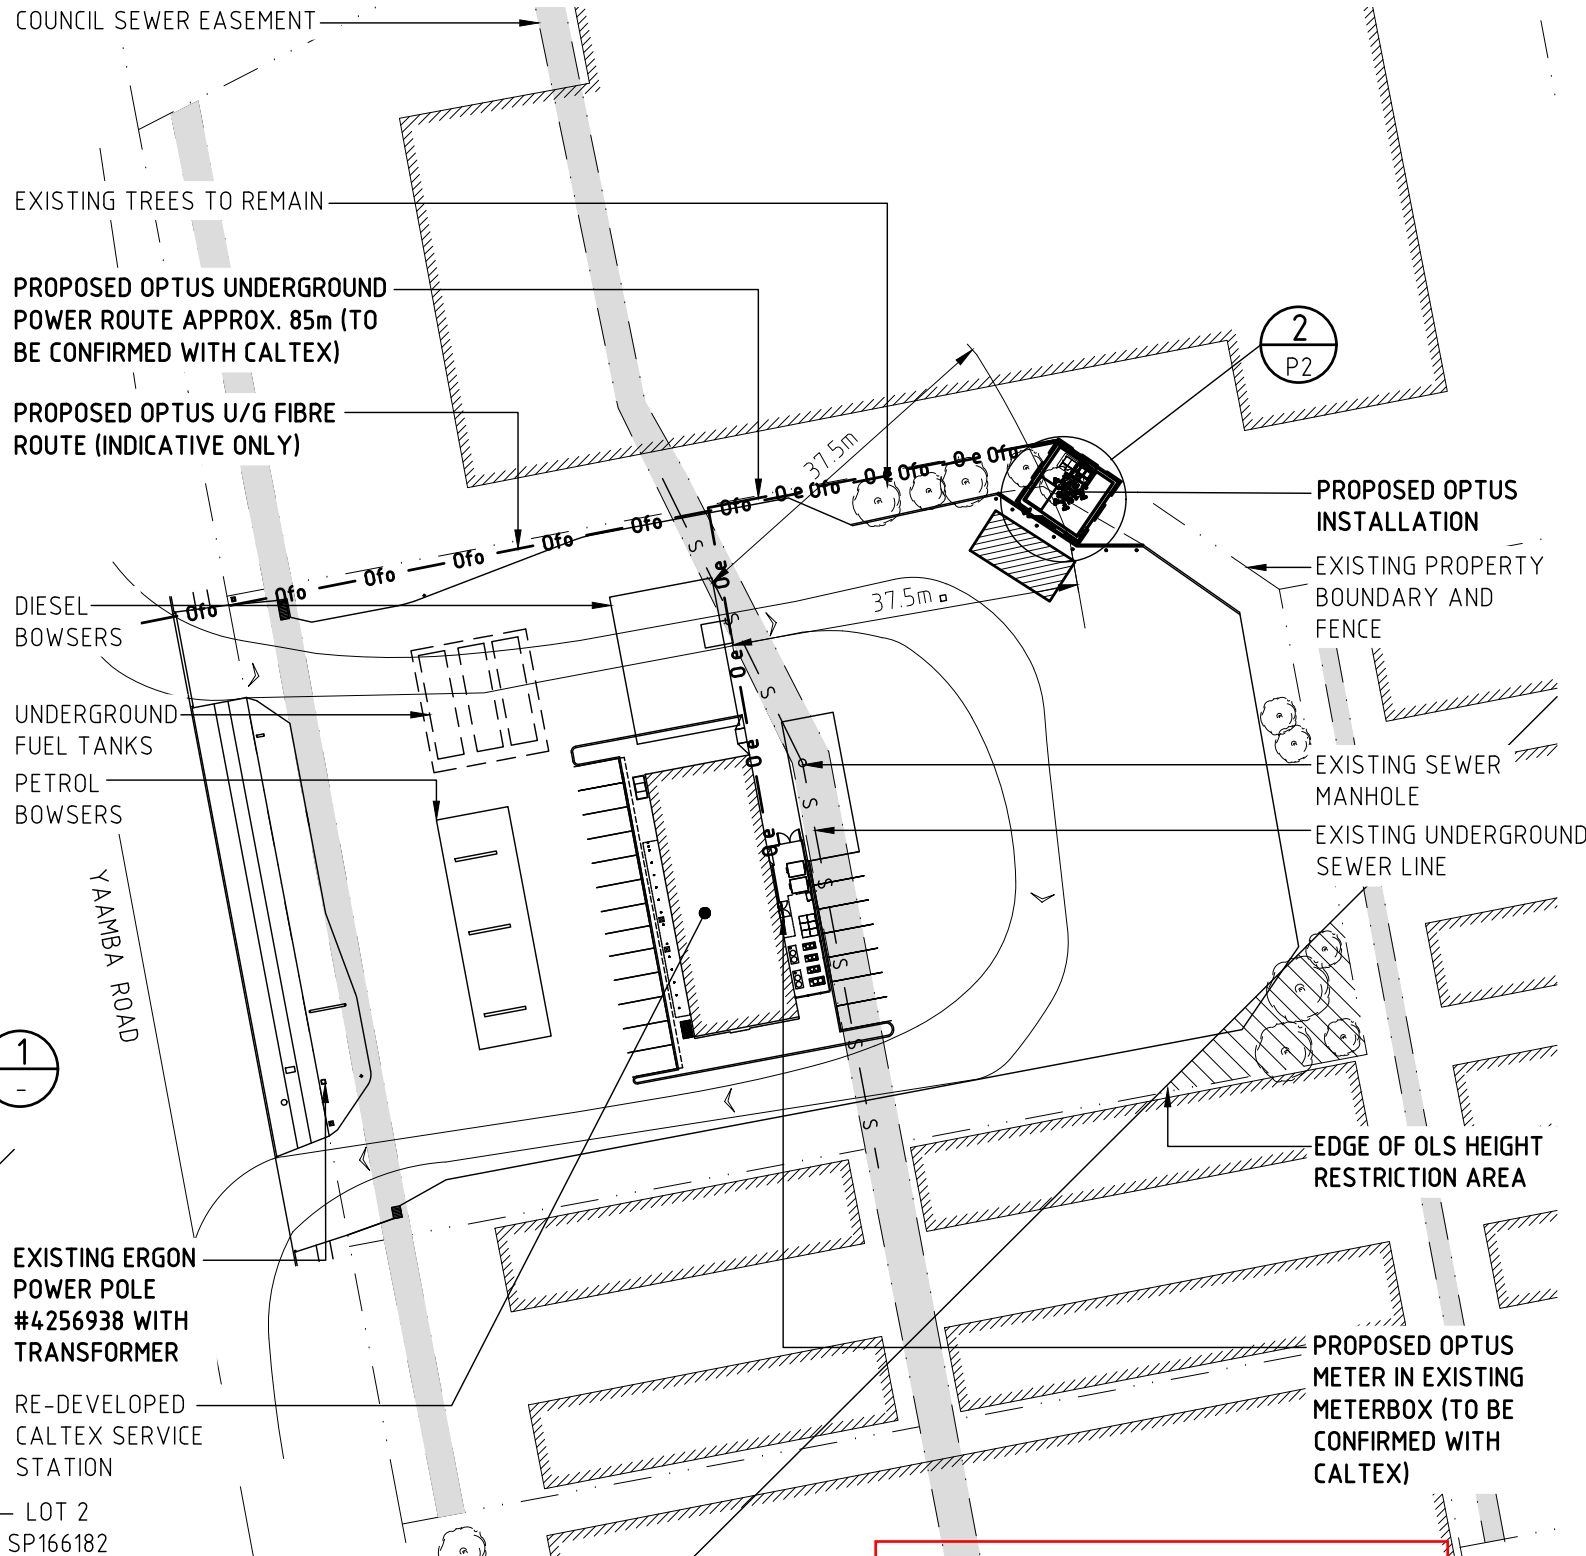

DETAIL
SCALE 1:800

ROCKHAMPTON REGIONAL COUNCIL
APPROVED PLANS
These plans are approved subject to the current conditions of approval associated with **Development Permit No.: D/43-2018**
Dated: 10 September 2018

NOTE:
THIS DRAWING IS DIAGRAMMATIC ONLY AND SHOULD NOT BE SCALED. DIMENSIONS, COORDINATES, AND LEVELS SHOWN ARE NOMINAL AND SUBJECT TO CONFIRMATION BY SURVEYOR.

SITE ADDRESS:
LOT 8/RP618822
CALTEX SERVICE STATION
524-528 YAAMBA ROAD
NORMAN GARDENS QLD 4701

- NOTES:**
- BASIS OF DESIGN**
 - > SITE INSPECTION 10/10/2017
 - PANEL ANTENNAS**
 - > 2-OFF PER SECTOR (EACH 2.6m LONG) AT EL 36m
 - > SECTOR 1 - 60°, SECTOR 2 - 160°, SECTOR 3 - 270°
 - > MOUNTED TO OPTUS STANDARD HEADFRAME
 - TRANSMISSION**
 - > VIA OPTUS FIBRE
 - > TO BE CONFIRMED BY OPTUS
 - EQUIPMENT**
 - > PROPOSED ICS 2 BAY OTC (FUTURE 3 BAY OTC), COLOURED "PALE EUCALYPT" SUPPORTED ON A CONCRETE SLAB
 - OPTUS MONOPOLE**
 - > 35m HIGH PROPOSED MONOPOLE WITH OPTUS STANDARD HEADFRAME
 - FEEDER CABLES/ HYBRID TRUNK CABLES**
 - > 1 OFF 9/18 MLEH ALL SECTORS
 - > LENGTH: 45m ALL SECTORS
 - SITE ACCESS**
 - > VIA YAAMBA ROAD
 - ANTENNA ACCESS**
 - > VIA EWP ACCESS ONLY
 - POWER SUPPLY**
 - > 3-PHASE SUPPLY IS AVAILABLE FROM ERGON ENERGY
 - > OPTUS TO CONNECT SEPARATE METERED SUPPLY
 - > DETAILS TO BE CONFIRMED
 - OTHER (PAINTING, LANDSCAPING, SCREENING)**
 - > EXISTING TREES/SHRUBS IN LOCAL AREA OF PROPOSED OPTUS COMPOUND TO BE TRIMMED AS REQUIRED (TREE WITHIN COMPOUND ARE TO BE REMOVED)
 - > BOLLARDS REQUIRED OUTSIDE COMPOUND FENCE FOR VEHICULAR PROTECTION

Rev	Date	Revision Details	Consultant	CAD	Designer	Verifier	Approver
01	26.10.17	ISSUED FOR APPROVAL	CATALYST	JW	MJB	CO	KM

HUAWEI TECHNOLOGIES (AU) PTY LTD
ABN 49 153 793 380
SYDNEY
LEVEL 6 TOWER B 799 PACIFIC HIGHWAY
CHATSWOOD NSW 2067
TEL: +61 2 9528 3888 FAX: +61 2 9411 8533
MELBOURNE
LEVEL 24 459 COLLINS STREET
MELBOURNE VIC 3000
TEL: +61 3 8610 0600 FAX: +61 3 9621 1575



Client:
OPTUS

Project:
MOBILE NETWORK AUSTRALIA
SITE No:- B1227 - C
NORMAN GARDENS
524-528 YAAMBA ROAD


Drawing Title:
DRAFT SITE PLAN

Drawing Status:
FOR APPROVAL


Drawing No.
B1227-P1

Revision
01

CAD File: Q:\QLD\B1227 Norman Gardens V1. SAED\Working Data\CAD\In progress drawings\B1227 Norman Gardens DSL.dwg Date: 07.11.2017 11:41 AM

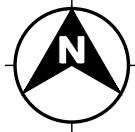

NOTE:
 THIS DRAWING IS DIAGRAMMATIC ONLY
 AND SHOULD NOT BE SCALED.
 DIMENSIONS, COORDINATES, AND LEVELS
 SHOWN ARE NOMINAL AND SUBJECT TO
 CONFIRMATION BY SURVEYOR.

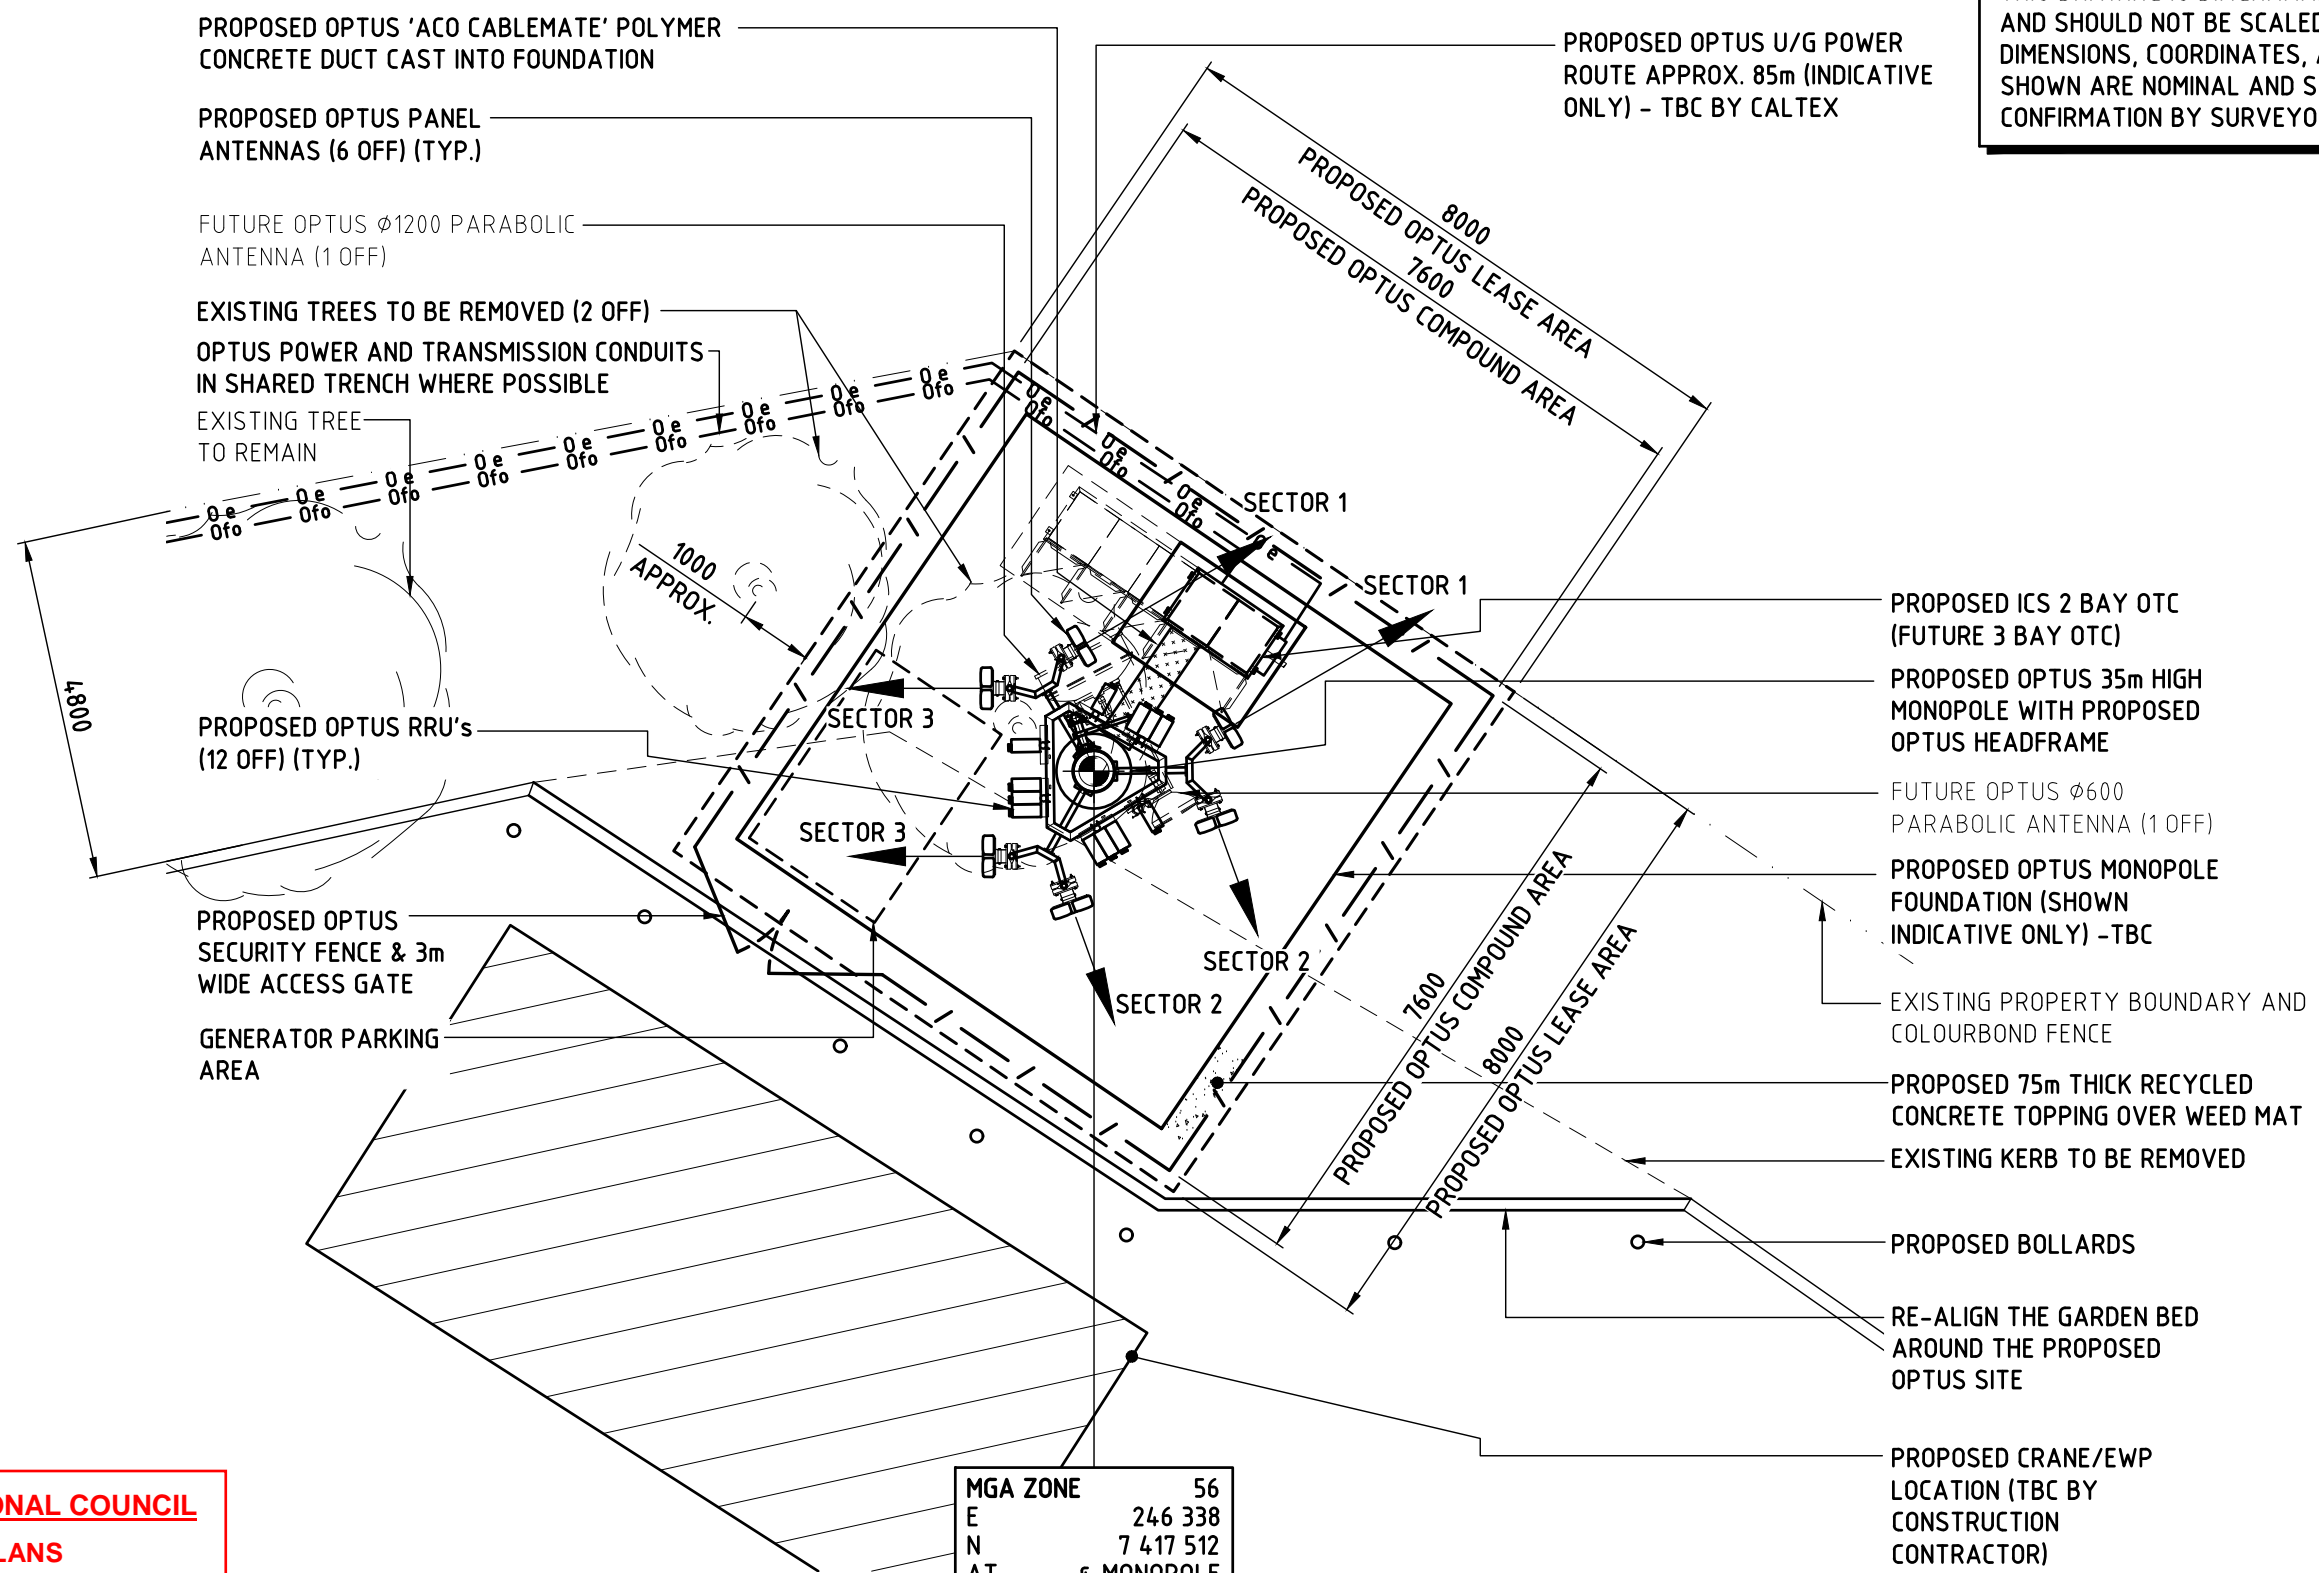


MGA ZONE 56
 E 246 338
 N 7 417 512
 AT € MONOPOLE

DETAIL SCALE 1:100 2
 P1

ROCKHAMPTON REGIONAL COUNCIL
APPROVED PLANS
 These plans are approved subject to the
 current conditions of approval associated with
Development Permit No.: D/43-2018
Dated: 10 September 2018

Rev	Date	Revision Details	Consultant	CAD	Designer	Verifier	Approver
01	26.10.17	ISSUED FOR APPROVAL	CATALYST	JW	MJB	CO	KM



HUAWEI TECHNOLOGIES (AU) PTY LTD
 ABN 49 153 793 380
 SYDNEY
 LEVEL 6 TOWER B 799 PACIFIC HIGHWAY
 CHATSWOOD NSW 2067
 TEL: +61 2 9528 3888 FAX: +61 2 9411 8533
 MELBOURNE
 LEVEL 24 459 COLLINS STREET
 MELBOURNE VIC 3000
 TEL: +61 3 8610 0600 FAX: +61 3 9621 1575

Client:



Project:
MOBILE NETWORK AUSTRALIA
 SITE No:- B1227 - C
 NORMAN GARDENS
 524-528 YAAMBA ROAD


Drawing Title:
DRAFT SITE LAYOUT
 Drawing Status:
FOR APPROVAL

Drawing No.
B1227-P2
 Revision
01

NOTE:
THIS DRAWING IS DIAGRAMMATIC ONLY
AND SHOULD NOT BE SCALED.

ROCKHAMPTON REGIONAL COUNCIL
APPROVED PLANS
These plans are approved subject to the
current conditions of approval associated with
Development Permit No.: D/43-2018
Dated: 10 September 2018

- EL 36.00m ▽
- € PROPOSED OPTUS PANEL ANTENNAS (6 OFF)
- € PROPOSED OPTUS RRU'S (12 OFF)
- € FUTURE OPTUS RRU'S (15 OFF)
- € FUTURE OPTUS COMBINERS (18 OFF)
- EL 35.00m ▽
- TOP OF MONOPOLE
- EL 32.00m ▽
- € FUTURE OPTUS Ø1200 PARABOLIC ANTENNAS (2 OFF) TBC
- € FUTURE OPTUS Ø600 PARABOLIC ANTENNAS (1 OFF) TBC

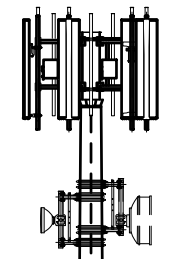

PROPOSED OPTUS FEEDER CABLES
TO RUN INTERNALLY TO THE
MONOPOLE

PROPOSED OPTUS 35m HIGH
MONOPOLE WITH PROPOSED
OPTUS HEADFRAME

EXISTING PROPERTY BOUNDARY AND
COLOURBOND FENCE

PROPOSED ICS 2 BAY OTC
(FUTURE 3 BAY OTC)

PROPOSED OPTUS SECURITY FENCE & 3m
WIDE ACCESS GATE

RE-DEVELOPED
CALTEX SERVICE
STATION

PROPOSED OPTUS METER IN
EXISTING METERBOX (TO BE
CONFIRMED WITH CALTEX)
(TBA m AHD) 0.00m ▽
GROUND LEVEL

PROPOSED BOLLARDS

PROPOSED OPTUS MONOPOLE
FOUNDATION (SHOWN
INDICATIVE ONLY) - TBC

PROPOSED OPTUS UNDERGROUND
POWER ROUTE APPROX. 85m (TO
BE CONFIRMED WITH CALTEX)

EAST ELEVATION
SCALE 1:200

Rev	Date	Revision Details	Consultant	CAD	Designer	Verifier	Approver
01	26.10.17	ISSUED FOR APPROVAL	CATALYST	JW	MJB	CO	KM

HUAWEI TECHNOLOGIES (AU) PTY LTD
ABN 49 153 793 380
SYDNEY
LEVEL 6 TOWER B 799 PACIFIC HIGHWAY
CHATSWOOD NSW 2067
TEL: +61 2 9528 3888 FAX: +61 2 9411 8533
MELBOURNE
LEVEL 24 459 COLLINS STREET
MELBOURNE VIC 3000
TEL: +61 3 8610 0600 FAX: +61 3 9621 1575

Client:

Project:
**MOBILE NETWORK
AUSTRALIA**
SITE No:- B1227 - C
NORMAN GARDENS
524-528 YAAMBA ROAD

Drawing Title:
DRAFT SITE ELEVATION

Drawing Status:
FOR APPROVAL

Drawing No.
B1227-P3

Revision
01